


VA NORTHERN INDIANA HEALTH CARE SYSTEM, FORT WAYNE

RENOVATE FIRST FLOOR, EAST WING FOR PACT, BUILDING 1 PROJECT: 610A4-12-107



VA NORTHERN INDIANA
HEALTH CARE SYSTEM
FORT WAYNE
2121 Lake Ave,
Fort Wayne, Indiana 46805


| ASBESTOS CONTAINING MATERIAL (ACM) AND LEAD BASED PAINT (LBP) STATEMENT (Place an "X" in the appropriate box.) | |
|--|---|
| This facility contains no known or suspected asbestos or LBP. | |
| This facility contains ___ asbestos and/or ___LBP that will be removed by the Air Force. | |
| This facility contains asbestos and/or LBP that will be removed under this contract. | X |
| This facility contains ___ asbestos and/or ___LBP that will be removed under a separate contract. | |

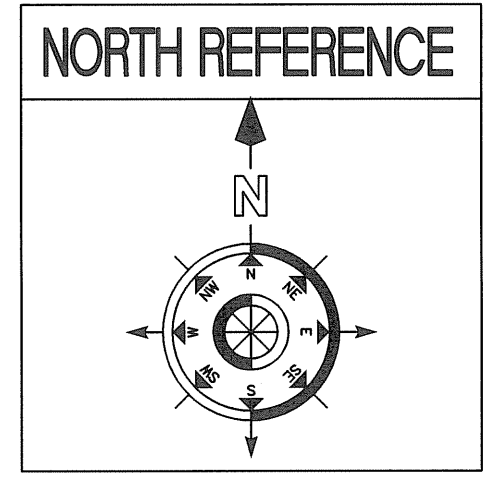

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LOCATION MAP


VICINITY MAP

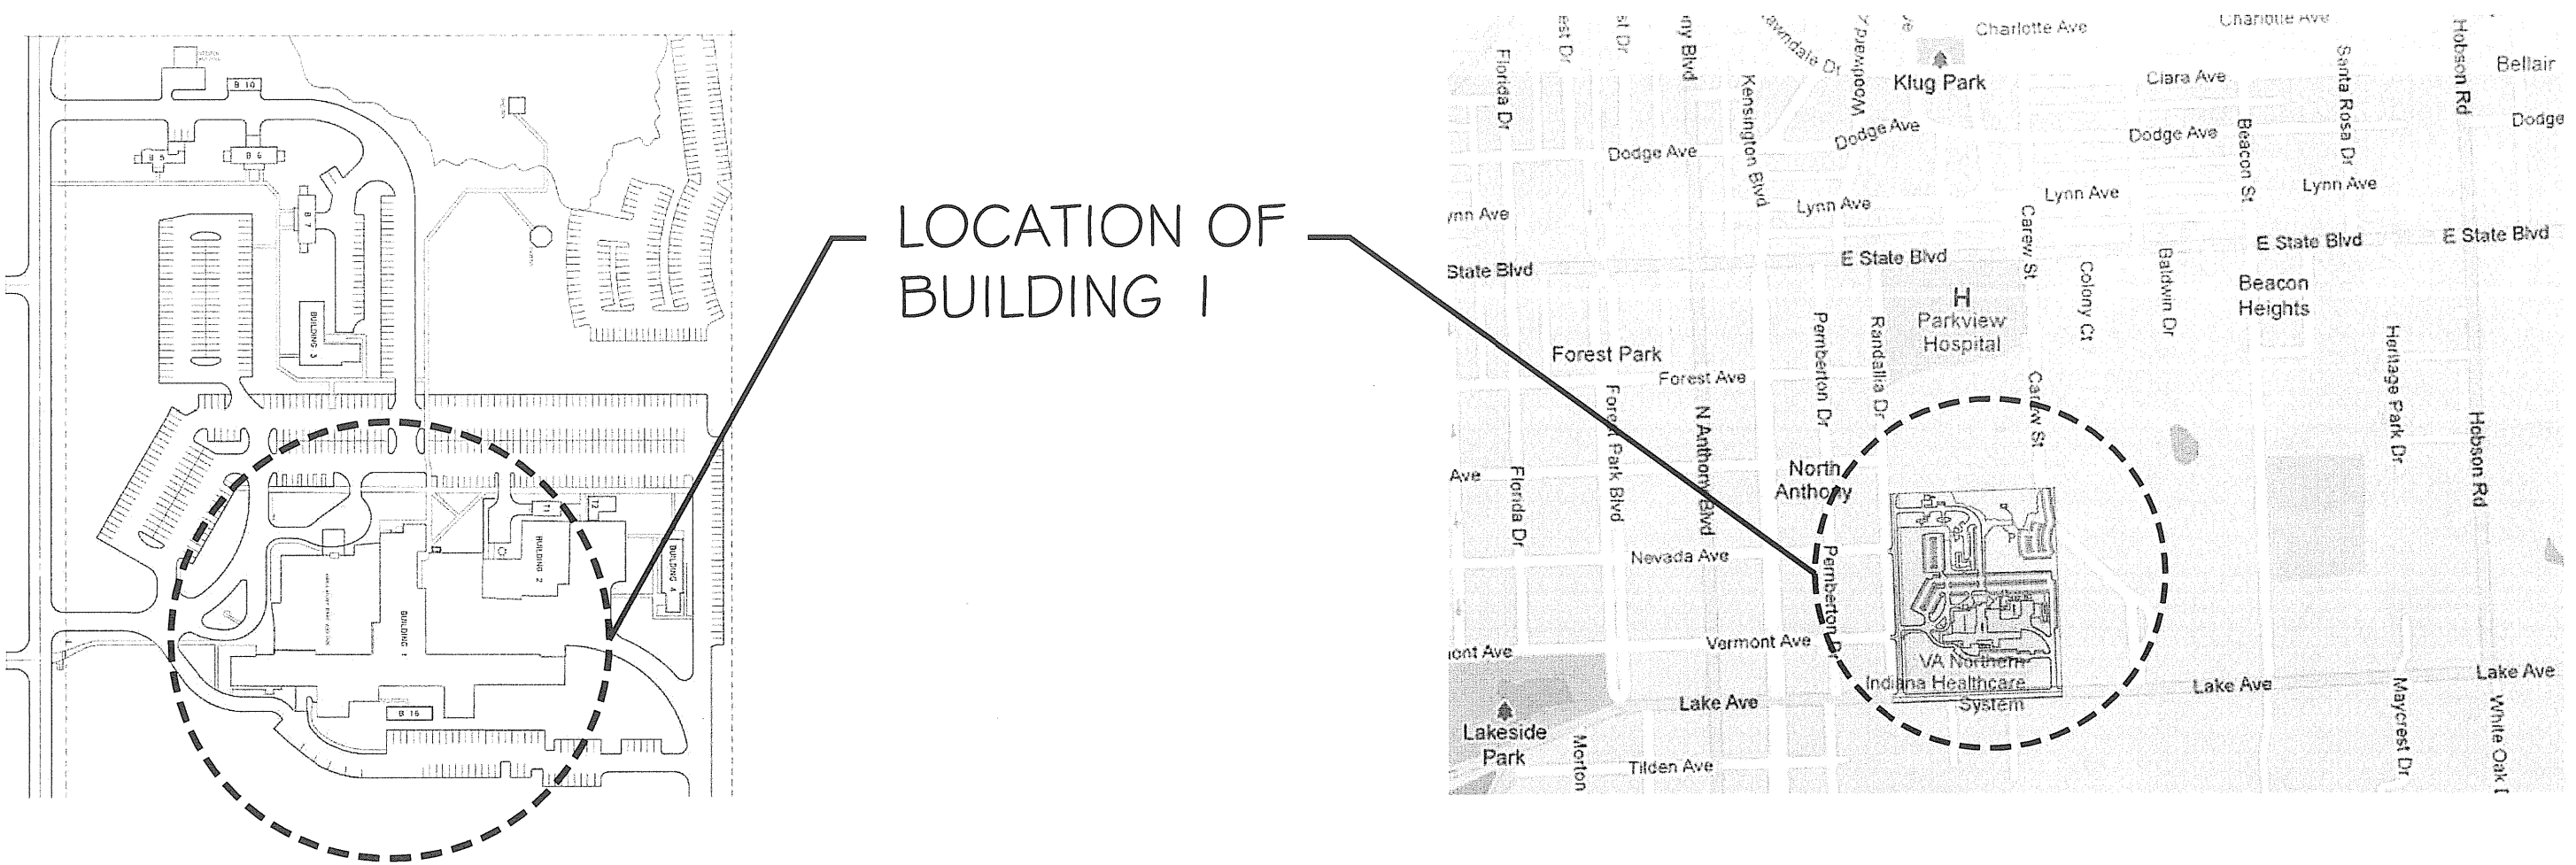


BIDDING DOCUMENTS
FULLY SPRINKLERED

| | | | | | | | | | | | | |
|-------------------|------------|--|---|--|---|--|--|--|--|---|---|---|
| 100% CD SUBMITTAL | 11/09/2012 | | VA Northern Indiana Health Care System, Fort Wayne 2121 Lake Ave, Fort Wayne IN 46805 | CONSULTANTS: | USFin Development, LLC 1105 West Wier Street Litchfield, Illinois 62556 Viridian Architectural Design, Inc. 2020 East Washington Blvd, Suite 200 Fort Wayne, Indiana 46803 | ARCHITECT/ENGINEERS: | 2760 SHADELAND STATION INDIANAPOLIS, IN 46256-3957 TEL 317.547.5080 FAX 317.543.0270 www.structurepoint.com Engineering Corporation The Fairmont Building 9245 Calumet Ave, Suite 205, Munster, IN 46321 (219) 636-2120 Fax (219) 636-1129 | Approved: Medical Center Director NAME: SIGNATURE: | Drawing Title COVER SHEET | Project Title Renovate First Floor East Wing for PACT | Project Number 610A4-12-107 Building Number 01 | Office of Construction and Facilities Management |
| BIDDING DOCUMENTS | 03/27/2013 | | | Approved: Medical Center Associate Director NAME: SIGNATURE: | | Approved: Engineering Service NAME: SIGNATURE: | | Approved: Project Director NAME: SIGNATURE: | Location 2121 Lake Ave., Fort Wayne, IN 46805 | Date 03/27/2013 | Checked DLW | |


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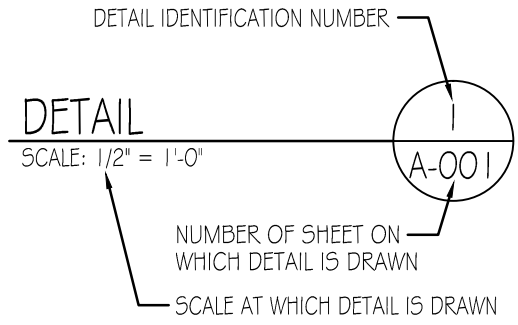
SYMBOL WHERE SECTION IS TAKEN

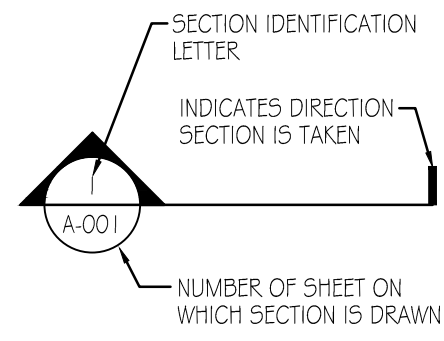


SUBTITLE FOR SECTION DRAWING

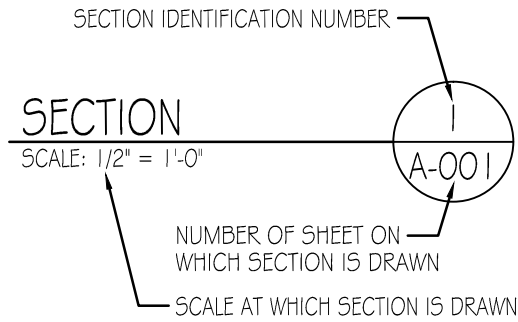

SYMBOL WHERE DETAIL IS TAKEN

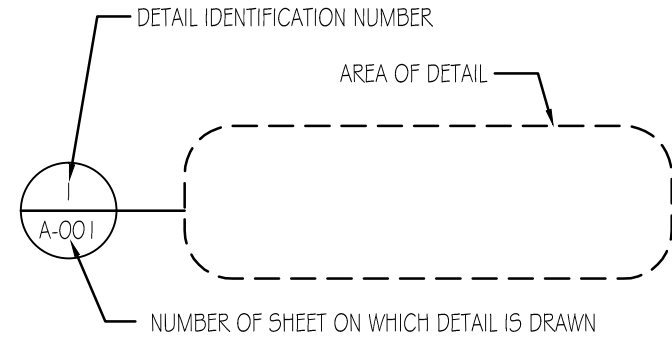

SUBTITLE FOR DETAIL DRAWING

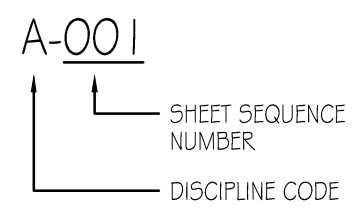


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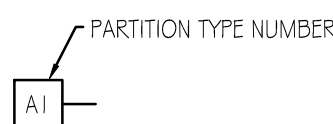
NORTH ARROW




WINDOW TYPE




DOOR NUMBER

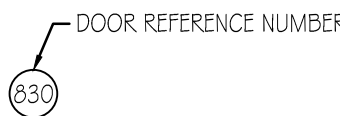


PARTITION TYPE

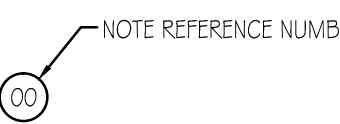

SHEET NOTE

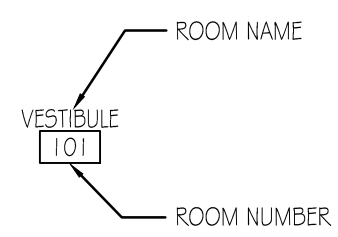

ROOM NAME & NUMBER

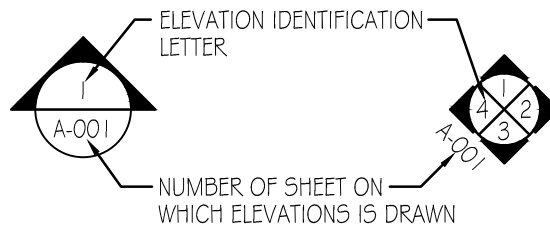


SYMBOL WHERE ELEVATION IS TAKEN

GENERAL NOTES

- THE CONTRACTOR SHALL REVIEW THE DRAWINGS AND UNDERSTAND THE SCOPE OF THE DRAWINGS TO BE THE FOLLOWING: THE DOCUMENTS (DRAWINGS, SPECIFICATIONS, ADDENDUM, ETC.) INDICATE THE GENERAL SCOPE OF THE PROJECT IN TERMS OF ARCHITECTURAL DESIGN CONCEPTS, THE DIVISION OF THE BUILDING, THE MAJOR ARCHITECTURAL ELEMENTS, THE MAJOR STRUCTURAL, MECHANICAL AND ELECTRICAL SYSTEMS. THE DOCUMENTS DO NOT AND ARE NOT INTENDED TO INDICATE OR DESCRIBE ALL THE WORK REQUIRED FOR FULL PERFORMANCE OF, AND COMPLETION OF THE REQUIREMENTS OF THE CONTRACT. ON THE BASIS OF THE GENERAL SCOPE INDICATED IN THESE DOCUMENTS, THE TRADE CONTRACTOR SHALL FURNISH ALL ITEMS REQUIRED FOR THE PROPER EXECUTION AND COMPLETION OF THE WORK.
- GENERAL CONTRACTOR IS TO FOLLOW AND OBEY THE LATEST VERSION OF ALL FEDERAL, STATE AND LOCAL CODES, LAWS, SAFETY REGULATIONS AND HAZARDOUS WASTE LAWS, ETC., INCLUDING OSHA, NFPA 101, LIFE SAFETY CODE, AND NEC.
- COORDINATE WORK OF ALL TRADES PRIOR TO STARTING CONSTRUCTION.
- ALL DIMENSIONS ARE TO FACE OF CONCRETE, FACE OF MASONRY, FACE OF METAL STUDS, OR COLUMN CENTERLINE, UNLESS NOTED OTHERWISE.
- DO NOT SCALE DRAWINGS. DIMENSIONS SHALL GOVERN EACH BUILDING COMPONENT LOCATION. BRING ANY DISCREPANCIES TO THE ARCHITECT'S ATTENTION IN WRITING IMMEDIATELY.
- CAULK JUNCTURES BETWEEN DIFFERENT MATERIALS.
- CAULK TOILET FIXTURES TO WALL PER SEALANT SCHEDULE IN SPECIFICATIONS.
- CAULK ALL COUNTERTOP BACKSPASHES TO WALL USING SILICONE SEALANT.
- PROVIDE GYPSUM BOARD CONTROL JOINTS WHERE NOTED AND AT UNINTERRUPTED WALL LENGTHS EXCEEDING 30'-0".
- ANY WOOD INSTALLED IN PARTITIONS SHALL BE FIRE RETARDANT TREATED.
- FIRE EXTINGUISHERS AND CABINETS TO COMPLY WITH NFPA 10.
- TYPICAL DISTANCE BETWEEN FINISHED WALL AND DOOR FRAME ON JAMB SIDE OF DOORS IS 4" U.N.O.

MATERIAL LEGEND

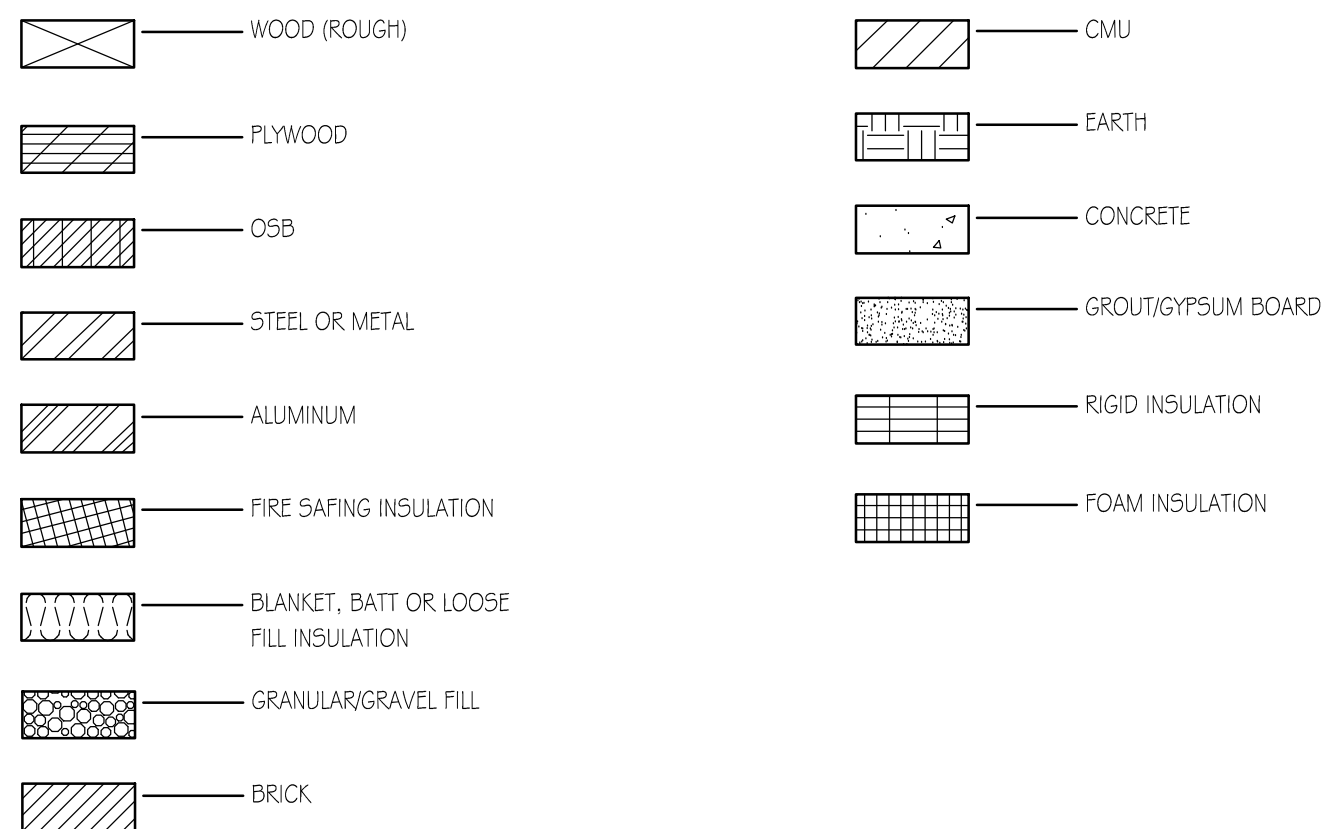

ARCHITECTURAL ABBREVIATIONS

| | | | | | |
|-----------|--|-----------------|---|------------|---|
| A LABEL | CLASS A DOOR | BLDG | BUILDING | CSB | CONCRETE SPLASH BLOCK |
| A/C | AIR CONDITION | BLKT | BLANKET | CSG | CASING |
| A/C UNIT | AIR CONDITIONING UNIT | BLVD | BOULEVARD | CSI | CONSTRUCTION SPECIFICATIONS INSTITUTE |
| A/E | ARCHITECT/ENGINEER | BM | BEAM OR BENCHMARK | CSK | COUNTER SUNK |
| AAMA | AMERICAN ARCHITECTURAL MANUFACTURERS ASSOCIATION | BOT | BOTTOM | CSMT | CASEMENT |
| AB | ANCHOR BOLT | BR | BEDROOM | CSWK | CASEWORK |
| ABC | AGGREGATE BASE COURSE | BRCG | BRACING | CT | CERAMIC TILE |
| AC | ASBESTOS CEMENT OR ASPHALTIC CONCRETE | BRDG | BRIDGING | CTB | CERAMIC TILE BASE |
| ACI | AMERICAN CONCRETE INSTITUTE | BRDG JST | BRIDGING JOIST | CTF | CERAMIC TILE FLOOR |
| ACS DR | ACCESS DOOR | BRG | BEARING | CTG | COATING |
| ACS FLR | ACCESS FLOOR | BRG PL | BEARING PLATE | CTR | CENTER CONTOUR |
| ACS PNL | ACCESS PANEL | BRKT | BRACKET | CTRL | CONTROL |
| ACST | ACOUSTIC | BRZ | BRONZE | CTV | CABLE TELEVISION |
| ACT | ACOUSTICAL CEILING TILE | BSMT | BASEMENT | CU | COPPER C |
| AD | AREA DRAIN | BTWN | BETWEEN | CU FT | CUBIC FEET |
| ADA | AMERICANS WITH DISABILITIES ACT | BU | BUSH | CU IN | CUBIC INCH |
| ADC | AUTOMATIC DOOR CLOSER | BUR | BUILT-UP ROOFING | CU YD | CUBIC YARD |
| ADDL | ADDITIONAL | C | CELSIUS CHANNEL | CURT | CURTAIN |
| ADDN | ADDITION | C | CHANNEL CELSIUS | CYL | CYLINDER |
| ADH | ADHESIVE | C CONC | CAST CONCRETE | CYL L | CYLINDER LOCK |
| ADJ | ADJACENT, ADJOINING, OR ADJUSTABLE | C LABEL | CLASS C DOOR | | |
| ADMIN | ADMINISTRATION | C TO C | CENTER TO CENTER | D | DEPTH OR PENNY (NAIL) |
| ADB | AUTOMATIC DOOR BOTTOM | CAB | CABINET | D LABEL | CLASS D DOOR |
| AFC | ABOVE FINISHED COUNTER | CAC | CEILING ATTENUATION CLASS | DAT | DATUM |
| AFF | ABOVE FINISHED FLOOR | CBB | CATCH BASIN OR CORNER BEAD | DB | DECIBEL |
| AFO | ABOVE FINISHED GRADE | CC | CEMENTITIOUS (BACKER) BOARD | DBL | DOUBLE |
| AFS | ABOVE FINISHED SLAB | CC | CUBIC CENTIMETER | DBL GLZ | DOUBLE GLAZE |
| AGA | AMERICAN GAS ASSOCIATION | CCTV | CLOSED CIRCUIT TELEVISION | DEG | DEGREE |
| AGC | ASSOCIATED GENERAL CONTRACTORS | CCW | COUNTERCLOCKWISE | DEL | DELETE |
| AGGR | AGGREGATE | CD | CONSTRUCTION DOCUMENTS OR CONTRACT DOCUMENTS | DEMO | DEMOLITION |
| AHJ | AUTHORITY HAVING JURISDICTION | CEM | CEMENT | DEPT | DEPARTMENT |
| AHR | ANCHOR | CEM PLAS | CEMENT PLASTER | DET | DETAIL |
| AHU | AIR HANDLING UNIT | CER | CERAMIC | DF | DRINKING FOUNTAIN |
| AIA | AMERICAN INSTITUTE OF ARCHITECTS | CF | CONTRACTOR FURNISHED | DIA | DIAMETER |
| AISC | AMERICAN INSTITUTE OF STEEL CONSTRUCTION | CF/CI | CONTRACTOR | DIAG | DIAGONAL DIAGRAM |
| ALT | ALTERNATE | CF/OI | FURNISHED/CONTRACTOR | DIAG | DIAGONAL |
| ALT NO | ALTERNATE NUMBER | CFLG | INSTALLED | DIFF | DIFFERENCE OR DIFFUSER |
| ALUM | ALUMINUM | CFM | CONTRACTOR FURNISHED/OWNER | DIM | DIMENSION |
| AMP | AMPERE | CFLG | INSTALLED | DIR | DIRECTION |
| AMT | AMOUNT | CFLG | COUNTERFLASHING | DISP | DISPENSER |
| ANOD | ANODIZE | CFM | CUBIC FEET PER MINUTE | DIST | DISTANCE |
| ANSI | AMERICAN NATIONAL STANDARDS INSTITUTE | CFM | CUBIC FEET PER MINUTE | DIV | DIVIDE OR DIVISION |
| ANT | ANTENNA | CFS | CUBIC FEET PER SECOND | DL | DEAD LOAD |
| APA | AMERICAN PLYWOOD ASSOCIATION | CG | CENTER OF GRAVITY OR CORNER GUARD | DOC | DOCUMENT |
| APPD | APPROVED | CGSFU | CERAMIC GLAZED STRUCTURAL FACING UNITS | DOUG FIR | DOUGLAS FIR |
| APPROX | APPROXIMATE | CH BD | CHALKBOARD | DOZ | DOZEN |
| APT | APARTMENT | CHEM | CHEMICAL | DR | DOOR, DRAIN, DRESSING ROOM, OR DRIVE |
| AR | AS REQUIRED | CHFR | CHAMFER | DR CL | DOOR CLOSER |
| ARCH | ARCHITECT | CHK | CHECK | DR FR | DOOR FRAME |
| ASB | ASBESTOS | CI | CAST IRON | DR OPNG | DOOR OPENING |
| ASI | ARCHITECT'S SUPPLEMENTAL INSTRUCTION | CIP | CAST-IN-PLACE | DSGN | DESIGN |
| ASKLR | AUTOMATIC SPRINKLER | CIR | CIRCLE | DW | DISHWASHER |
| ASPH | ASPHALT | CIRC | CIRCULAR | DWG | DRAWING |
| ASSN | ASSOCIATION | CJ | CONSTRUCTION JOINT OR CONTROL JOINT | DWTR | DUMBWAITER |
| ASTM | AMERICAN SOCIETY FOR TESTING AND MATERIALS | CL | CENTER LINE | E | EAST |
| ATACH | ATTACHMENT | CLDG | CLADDING | E LABEL | CLASS E DOOR |
| ATM | AUTOMATIC TELLER MACHINE | CLG | CEILING | EFF | EFFICIENCY |
| ATS | AUTOMATIC TRANSFER SWITCH | CLG HT | CEILING HEIGHT | EFS | EXTERIOR FINISH SYSTEM |
| AUTO | AUTOMATIC | CLR | CLEAR | EIFS | EXTERIOR INSULATION AND FINISH SYSTEM |
| AUX | AUXILIARY | cm ² | SQUARE CENTIMETER | EJ | EXPANSION JOINT |
| AV | AUDIO VISUAL | cm ³ | CUBIC CENTIMETER | EL | ELEVATION |
| AVE | AVENUE | CM | CONSTRUCTION MANAGEMENT | ELAST | ELASTOMERIC |
| AVG | AVERAGE | CNR | CORNER | ELEC | ELECTRIC |
| AW | ACID WASTE | CNTR | COUNTER | ELEC DR OP | ELECTRIC DOOR OPENER |
| AWI | ARCHITECTURAL WOODWORKING INSTITUTE | CO | CARBON MONOXIDE, CERTIFICATE OF OCCUPANCY, CLEANOUT, OR COMPANY | ELEV | ELEVATOR |
| AWPA | AMERICAN WOOD PRESERVERS' ASSOCIATION | CO ₂ | CARBON DIOXIDE | EMER | EMERGENCY |
| AWS | AMERICAN WELDING SOCIETY | COL | COLUMN | EMER SHR | EMERGENCY SHOWER |
| AWT | ACOUSTICAL WALL TREATMENT | COM | COMMON | ENCL | ENCLOSURE |
| B LABEL | CLASS B DOOR | COMB | COMBINATION, COMBINED | ENGR | ENGINEER |
| B PL | BASE PLATE | COMM | COMMUNICATION | ENVIR | ENVIRONMENT |
| BALC | BALCONY | COMP | COMPONENT | EPA | ENVIRONMENTAL PROTECTION AGENCY |
| BAT | BATTEN | CONC | CONCRETE | EPDM | ETHYLENE PROPYLENE DIENE MONOMER |
| BB | BULLETIN BOARD | CONC FLR | CONCRETE FLOOR | EPO | EMERGENCY POWER OFF |
| BD FT | BOARD FEET (FOOT) | COND | CONDENSER OR CONDITION | EPS | EXPANDED POLYSTYRENE BOARD (INSULATION) |
| BEV | BEVEL | CONF | CONFERENCE | EQ | EQUAL |
| BHMA | BUILDER'S HARDWARE | CONN | CONNECT | EQL SP | EQUALLY SPACED |
| BI-FLD DR | BIFOLDING DOORS | CONSTR | CONSTRUCTION | EQUIP | EQUIPMENT |
| BITUM | BITUMINOUS | CONTR | CONTRIBUTE | EQUIV | EQUIVALENT |
| BKG | BACKING | COORD | COORDINATE | ERD | EXISTING ROOF DRAIN |
| BLD | BUILD | CORR | CORRIDOR | ESC | ESCAPE OR ESCUTCHEON |
| | | CPW | CRITICAL PATH METHOD | ESCAL | ESCALATOR |
| | | CPRS | COMPRESSIBLE | ESMT | EASEMENT |
| | | CPT | CARPET | ESP | ESPECIALLY |
| | | CRS | COLD ROLLED STEEL | EST | ESTIMATE |
| | | CRSI | CONCRETE REINFORCING STEEL INSTITUTE | ETC | AND SO FORTH OR ET CETERA |
| | | | | EW | EACH WAY |

BIDDING DOCUMENTS FULLY SPRINKLERED

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|--|--|--|--|--|--|---|--|--|--|---|--|---|--|--|--|---|--|
| BIDDING DOCUMENTS 03/27/2013 Revisions: _____ Date: _____ | | VA Northern Indiana Health Care System, Fort Wayne 2121 Lake Ave., Fort Wayne IN 46805 | | CONSULTANTS: USFin Development, LLC 1105 West Weir Street Litchfield, Illinois 62556 Viridian Architectural Design, Inc. 2020 East Washington Blvd, Suite 200 Fort Wayne, Indiana 46803 | | ARCHITECT/ENGINEERS: AMERICAN STRUCTUREPOINT INC. 7280 SHADELAND STATION INDIANAPOLIS, IN 46256-9957 TEL 317.547.5580 FAX 317.543.0270 www.structurepoint.com EnerTronics ENERGY TO EXCEL Engineering Corporation The Fairmont Building 92445 Calumet Ave., Suite 205, Munster, IN 46321 (219) 836-2120 Fax (219) 836-1129 | | Approved: Medical Center Director NAME: _____ SIGNATURE: _____ Approved: Medical Center Associate Director NAME: _____ SIGNATURE: _____ | | Drawing Title SYMBOLS/LEGEND/ARCHITECTURAL ABBREVIATIONS Approved: Engineering Service NAME: _____ SIGNATURE: _____ Approved: Project Director NAME: _____ SIGNATURE: _____ | | Project Title Renovate First Floor East Wing for PACT Location 2121 Lake Ave., Fort Wayne, IN 46805 Date 03/27/2013 Checked DLW Drawn TKP | | Project Number 610A4-12-107 Building Number 01 Drawing Number GI-002 Dwg. 2 of 58 | | Office of Construction and Facilities Management Department of Veterans Affairs | |
|--|--|--|--|--|--|---|--|--|--|---|--|---|--|--|--|---|--|

three inches = one foot
one and one half inches = one foot
one inch = one foot
one quarter inch = one foot
one eighth inch = one foot
one eighth inch = one foot

EWC ELECTRIC WATER COOLER
EWS EYE WASH STATION
EXH EXHAUST
EXIST EXISTING
EXP EXPANSION OR EXPOSED
EXP BT EXPANSION BOLT
EXST GR EXISTING GRADE
EXT EXTERIOR, EXTERNAL, OR EXTINGUISHER
EXT GR EXTERIOR GRADE
F FAHRENHEIT OR FEMALE
FAB FIRE ALARM
FAC FABRIC
FACIL FACTOR
FAS FASCIA
FAS BD FASCIA BOARD
FCO FLOOR CLEANOUT
FCTY FACTORY
FD FLOOR DRAIN
FDC FIRE DEPARTMENT CONNECTION
FDTN FOUNDATION
FE FIRE EXTINGUISHER
FEC FIRE EXTINGUISHER CABINET
FF FINISH FACE
FF EL FINISH FLOOR ELEVATION
FF&E FURNITURE, FIXTURE, AND EQUIPMENT
FH FLAT HEAD OR FLAT HEAD SCREWS
FHC FIRE HOSE CABINET
FHMS FLAT HEAD MACHINE SCREW
FHP FULL HEIGHT PARTITION
FHWFS FLAT HEAD WOOD SCREW
FIG FIGURE
FIL FILLET
FIN FINISH
FIN FLR FINISH FLOOR
FIN GR FINISH GRADE
FIN WD FINISH WOOD
FIXT FIXTURE
FL FLOORLINE
FLASH FLASHING
FLDG FOLDING
FLEX FLEXIBLE
FLG FLOORING
FLR FIN FLOOR FINISH
FLR SK FLOOR SINK
FLUOR FLUORESCENT
FLUOR FIX FLUORESCENT FIXTURE
FM FACTORY MUTUAL
FM-G FACTORY MUTUAL GLOBAL
FO FINISHED OPENING
FOC FACE OF CONCRETE OR FACE OF CURB
FOF FACE OF FINISH
FOM FACE OF MASONRY
FOS FACE OF SLAB OR FACE OF STUD
FOUNT FOUNTAIN
FOW FACE OF WALL
FP FIRE PROTECTION OR FIREPROOF
FPM FEET PER MINUTE
FPS FEET PER SECOND
FR FIRE RATING, FIRE RESISTANT, OR FRAME
FR SNK FLUSHING RIM SINK
FREQ FREQUENCY
FRMG FRAMING
FRP FIBER REINFORCED POLYESTER OR FIBERGLASS REINFORCED PLASTIC
FRZ FREEZER
FS FEDERAL SPECIFICATION
FSTNR FASTENER
FT FEET OR FOOT
FTG FOOTING
FURG FURRING
FURN FURNISH OR FURNITURE
FUT FUTURE
FWC FABRIC WALLCOVERING
GA GAGE OR GYPSUM ASSOCIATION
GAL GALLON
GALV GALVANIC OR GALVANIZED
GALV STL GALVANIZED STEEL
GB GRAB BAR
GC GENERAL CONTRACTOR
GD GUARD
GDR GUARD RAIL
GEN GENERAL OR GENERATOR
GFRG GLASS-FIBER-REINFORCED CONCRETE
GFRG GLASS-FIBER-REINFORCED GYPSUM
GFRP GLASS-FIBER-REINFORCED PLASTIC
GI GALVANIZED IRON
GL GLASS
GL BLK GLASS BLOCK
GLU LAM GLUED LAMINATED WOOD
GR FL GROUND FLOOR
GRAN GRANITE
GRTG GRATING
GSB GYPSUM SHEATHING BOARD
GSM GALVANIZED SHEET METAL
GSJ GLAZED STRUCTURAL UNIT
GT GROUT
GUAR GUARANTEE
GUT GUTTER
GYP GYPSUM
GYP BD GYPSUM BOARD
GYP PLAS GYPSUM PLASTER

H HIGH
H PLAM HIGH PRESSURE PLASTIC LAMINATE
HAZ MAT HAZARDOUS MATERIALS
HB HOSE BIBB
HC HOLLOW CORE
HCWD HOLLOW CORE WOOD DOOR
HDBD HARDBOARD
HDNR HARDENER
HDO HIGH DENSITY OVERLAY
HDR HEADER
HDW HARDWARE
HDWD HARDWOOD
HEPA HIGH EFFICIENCY PARTICULATE AIR (FILTER)
HEX HEXAGON
HF HIGH FREQUENCY
HGR HANGER
HM HECTOMETER
HM HOLLOW METAL
HMD HOLLOW METAL DOOR
HMDF HOLLOW METAL DOOR AND FRAME
HMF HOLLOW METAL FRAME
HNDRL HANDRAIL
HO HOLD OPEN
HORIZ HORIZONTAL
HOSP HOSPITAL
HP HIGH PRESSURE OR HORSEPOWER
HQ HEADQUARTERS
HS HEAT-STRENGTHENED (GLASS) OR HIGH STRENGTH
HSE HOUSE
HSKPG HOUSEKEEPING
HST HOIST
HT HEIGHT
HVAC HEATING, VENTILATING, AND AIR CONDITIONING
HYV HEAVY
HYD HYDRANT
HYDR HYDRAULIC
I INTERSTATE (HIGHWAY) OR MOMENT OF INERTIA
IAQ INDOOR AIR QUALITY
IBC INTERNATIONAL BUILDING CODE
ID IDENTIFICATION, INSIDE DIAMETER, OR INTERIOR DESIGN IDENTIFICATION NUMBER
ID NO ILLUMINATION
INCL INCLUDED
IND INDEPENDENT OR INDUSTRIAL
INFO INFORMATION
INSUL INSULATION
INT INTERIOR
INTERCOM INTERCOMMUNICATION
INTL INTERNATIONAL
IRMA INVERTED ROOF MEMBRANE ASSEMBLY
IWH INSTANTANEOUS WATER HEATER
JAN JANITOR
J-BOX JUNCTION BOX
KD KILN DRIED OR KNOCKED DOWN
KIT KITCHEN
KO KNOCKOUT
KPL KICKPLATE
L ANGLE
LAB LABORATORY
LAD LADDER
LAM LAMINATE
LAM GL LAMINATED GLASS
LAU LAUNDRY
LAV LAVATORY
LBR LUMBER
LBS POUND
LD BRG LOAD-BEARING
LDR LEADER
LED LIGHT EMITTING DIODE
LF LINEAR FEET (FOOT)
LH LEFT HAND
LHR LEFT HAND REVERSE
LHR LEFT HAND REVERSE LATENT HEAT RATIO
LIB LIBRARY
LIN LINEAR
LINO LINEOLEUM
LIQ LIQUID
LKR LOCKER
LKR RM LOCKER ROOM
LKWASH LOCKWASHER
LL LEAD LINED
LLH LONG LEG HORIZONTAL
LLV LONG LEG VERTICAL
LMST LIMESTONE
LNDSCP LANDSCAPE
LR LIVING ROOM
LRG LARGE
LRV LOUVERED ROOF VENT
LT LIGHT
LT GA LIGHT GAGE
LT WT LIGHTWEIGHT
LTG LIGHTING
LTNG LIGHTNING
LVD LOUVERED
LVR LOUVER
LWC LIGHTWEIGHT CONCRETE
LWIC LIGHTWEIGHT INSULATING CONCRETE LAYER
LYR LAYER

MACH MACHINE
MACH RM MACHINE ROOM
MAINT MAINTENANCE
MAN MANUAL
MATL MATERIAL
MATV MASTER ANTENNA TELEVISION SYSTEM
MAX MAXIMUM
MB MACHINE BOLT
MCB METAL CORNER BEAD
MD DECK
ME MECHANICAL ENGINEER
MEAS MEASURE
MECH MECHANICAL
MECH RM MECHANICAL ROOM
MED MEDICAL MEDIUM
MED MEDIUM MEDICAL
MEK METHYL ETHYL KETONE
MEL MELAMINE
MEMB MEMBRANE
MEMO MEMORANDUM
MEZZ MEZZANINE
MF MILL FINISH
MFD MANUFACTURED
MFG MANUFACTURING
MFR MANUFACTURER
MFR REC MANUFACTURER'S RECOMMENDATION
MGT MANAGEMENT
MH MANHOLE
MIC MICROPHONE
MID MIDDLE
MIL STD MILITARY STANDARD
MIN MINIMUM
MIN MINUTE
MIR MINUTE MINIMUM
MISC MISCELLANEOUS
MIT MITER
MKR MARKER
ML METAL LATH
MLDG MOLDING (MOULDING)
MLWK MILLWORK
mm MILLIMETER
MO MASONRY OPENING OR MOTOR OPERATED
MOD MODEL, MODIFY OR MODULE
MOD BIT MODIFIED BITUMEN
MON MONITOR
MOPR MOP RACK
MR MOISTURE RESISTANT
MS MACHINE SCREW OR MOP SINK
MTD MOUNTED
MTG MOUNTING
MTL METAL
MULL MULLION
MW MICROWAVE
MWP MEMBRANE WATERPROOFING
N NORTH
NA NOT APPLICABLE
NAAMM NATIONAL ASSOCIATION OF ARCHITECTURAL METAL MANUFACTURERS
NAT NATURAL
NATL NATIONAL
NC NOISE CRITERIA
NCOMBL NONCOMBUSTIBLE
NEC NATIONAL ELECTRICAL CODE
NEG NEGATIVE
NEMA NATIONAL ELECTRICAL MANUFACTURERS ASSOCIATION
NEUT NEUTRAL
NFPA NATIONAL FIRE CODE
NFPA NATIONAL FIRE PROTECTION ASSOCIATION
NIC NOT IN CONTRACT
NO NUMBER
NOM NOMINAL
NR NOISE REDUCTION
NRC NOISE REDUCTION COEFFICIENT
NRCA NATIONAL ROOFING CONTRACTORS ASSOCIATION
NRP NONREMOVABLE
NS NARROW STILE
NUM NUMERAL
O/O OUT TO OUT
O OXYGEN
OC ON CENTER
OCC OCCUPY
OCT OCTAGON
OD OUTSIDE DIAMETER OUTSIDE DIMENSION
OD OUTSIDE DIMENSION OUTSIDE DIAMETER
OF/CI OWNER FURNISHED/CONTRACTOR INSTALLED
OFD OVERFLOW DRAIN
OFF OFFICE
OF/OI OWNER FURNISHED/OWNER INSTALLED
OH OVERHANG
OH DR OVERHEAD (COILING) DOOR
OPH OPPOSITE HAND
OPNG OPENING
OPP OPPOSITE
OPR OPERABLE
OPT OPTIONAL
OR OPERATING ROOM OR OUTSIDE
ORD ORDINANCE OR OVERFLOW ROOF DRAIN
ORG ORGANIC
ORIG ORIGINAL
ORN ORNAMENTAL

ARCHITECTURAL ABBREVIATIONS

OSHA OCCUPATIONAL SAFETY AND HEALTH ADMINISTRATION
OUT OUTLET
OZ OUNCE
PAR PARALLEL OR PARAPET
PARA PARAGRAPH
PART PARTIAL
PAT PATTERN
PB PUSHBUTTON
PBD PARTICLEBOARD
PC POLYCARBONATE OR PORTLAND CEMENT
PCA PORTLAND CEMENT ASSOCIATION
PCC PRECAST CONCRETE
PCCP CONCRETE PAVEMENT
PCD PAPER CUP DISPENSER
PCF POUNDS PER CUBIC FOOT
PCP PORTLAND CEMENT PLASTER
PED PEDESTAL
PEN PENETRATE
PEND PENDANT
PERF PERFORATED
PERIM PERIMETER
PERCT PERPENDICULAR
PCBD PEGBOARD
PHAR PHARMACY
PHOTO PHOTOGRAPH
PHS PHILLIPS HEAD SCREW
PKG PACKAGE
SECT PROPERTY LINE
PL PLATE GLASS
PL GL PLASTIC LAMINATE
PLAS PLASTER OR PLASTIC
PLBG PLUMBING
PLYWD PLYWOOD
PMTL PAINTED METAL
PNEU PNEUMATIC
PNL PANEL
PO POST OFFICE PURCHASE ORDER
PO PURCHASE ORDER POST OFFICE
POLY POLYETHYLENE (PLASTIC)
PR PAIR
PRCST PRECAST
PREFAB PREFABRICATE
PREFIN PREFINISH
PRELIM PRELIMINARY
PREP PREPARATION
PRESS PRESSURE
PREV PREVIOUS
PRKG PARKING
PRMLD PREMOLDED
PROJ PROJECT
PROP PROPERTY
PSF POUNDS PER SQUARE FOOT
PSI POUNDS PER SQUARE INCH
PT PAINT, PNEUMATIC TUBE, OR PRESSURE TREATED
PTD PAPER TOWEL DISPENSER
PTN PARTITION
PVC POLYVINYL CHLORIDE (PLASTIC)
PVG PAVING
PWR POWER
QA QUALITY ASSURANCE
QC QUALITY CONTROL
QRY QUARRY
QT QUARRY TILE
QTB QUARRY TILE BASE
QTF QUARRY TILE FLOOR
QTR QUARTER
QTY QUANTITY
QUAD QUADRANT
QUAL QUALITY
R RADIUS OR RISER
RAD RADIATOR
RB RESILIENT BASE OR RUBBER
RB HK ROBE HOOK
RBM REINFORCED BRICK MASONRY
RBR RUBBER
RC REMOTE CONTROL
RCP REFLECTED CEILING PLAN
RCVR RECEIVER
RD ROAD OR ROOF DRAIN
RECEP RECEIVED
RECPT RECEPTACLE
RECT RECTANGLE
REF REFERENCE OR REFRIGERATOR
REFR REFRACTORY REFRIGERATION
REFR REFRIGERATION REFRACTORY
REG REGISTER
REINF REINFORCE
REP REPAIR
REPL REPLACE
REQ REQUIRE
REQD REQUIRED
RESIL RESILIENT
RET RETURN
REV REVISION
RF RADIO FREQUENCY
RFG ROOFING
RFI REQUEST FOR INFORMATION
RFP REQUEST FOR PROPOSAL
RH RIGHT HAND
RHMS ROUND HEAD MACHINE SCREW
RHR RIGHT HAND REVERSE
RHWS ROUND HEAD WOOD SCREW
RL RAILING
RM ROOM
RND ROUND
RO ROUGH OPENING
ROW RIGHT OF WAY

RPM REVOLUTIONS PER MINUTE
RS ROUGH SAWN
RT RIGHT
RV ROOF VENT
RVS REVERSE
RWD REDWOOD
RWL RAIN WATER LEADER
SALV SALVAGE
SAMP SAMPLE
SAN SANITARY
SAT SUSPENDED ACOUSTICAL TILE
SATC SUSPENDED ACOUSTICAL TILE CEILING
SB SPLASH BLOCK
SBS STYRENE BUTADIEN STYRENE
SBSTR SUBSTRATE
SC SHADING COEFFICIENT OR SOLID CORE
SCH SCHOOL
SCHD SCHEDULE
SCHEM SCHEMATIC
SCP SCUPPER
SCRN SCREENER
SCT STRUCTURAL CLAY TILE
SCWD SOLID CORE WOOD DOOR
SD SHOP DRAWINGS, SMOKE DETECTOR, OR SOAP DISPENSER;
SDG SIDING
SECT SECTION
SEG SEGMENT
SEL SELECT
SEP SEPARATE
SF SQUARE FOOT (FEET)
SFTWD SOFTWOOD
SGD SLIDING GLASS DOOR
SGL SINGLE
SHR SHOWER
SHR HD SHOWER HEAD
SHRD SHOWER DRAIN
SHT SHEET
SHT MTL FLASH SHEET METAL (FLASHING)
SHTHG SHEATHING
SHV SHELVING
SIM SIMILAR
SJO SCORED JOINT
SJI STEEL JOIST INSTITUTE
SK SKETCH
SKLT SKYLIGHT
SLD WDW SLIDING WINDOW
SLDG SLIDING
SLNT SEALANT
SM SHEET METAL
SMK SMOKE
SND SANITARY NAPKIN DISPENSER
SND INS SOUND INSULATION
SNDU SANITARY NAPKIN DISPOSAL UNIT
SPEC SPECIFICATION
SPKLR SPRINKLER
SPKR SPEAKER
SPLY SUPPLY
SQ SQUARE
SQ IN SQUARE INCH
SQ YD SQUARE YARD
SS SANITARY SEWER OR SERVICE SINK
SST STAINLESS STEEL
ST STAIRS OR STREET
STC SOUND TRANSMISSION CLASS
STD STANDARD
STIF STIFFENER
STL JST STEEL JOIST
STL LNTL STEEL LINTEL
STL PL STEEL PLATE
STL RF DK STEEL ROOF DECK
STL TB STEEL TUBE
STL TR STEEL TRUSS
STNLS STAINLESS
STOR STORAGE
STR STRINGERS
STRUCT STRUCTURAL
STRUCT STL STRUCTURAL STEEL
SUB SUBSTITUTE
SURF SURFACE
SUSP SUSPENDED
SUSP CLG SUSPENDED CEILING
SV SHEET VINYL
SW SWITCH
SWDR SWING DOOR
SYM SYMBOL
SYNTH SYNTHETIC
SYS SYSTEM
T TREAD
T&G TONGUE AND GROOVE
T&M TIME AND MATERIALS
TB THROUGH BOLT OR TOWEL BAR
TCA TILE COUNCIL OF AMERICA
TCP TELEPHONE CONTROL PANEL; TEMPERATURE CONTROL PANEL; TRAFFIC CONTROL PLAN
TECH TECHNICAL
TEL TELEPHONE
TEMP TEMPERATURE OR TEMPORARY
TER TERRAZZO
THD THREAD
THERM THERMAL
THK THICKNESS
THRES THRESHOLD
THRU THROUGH
THRUOUT THROUGHOUT
TK BD TACKBOARD
TMPD TEMPERED
TMPD GL TEMPERED GLASS

TN TRUE NORTH
TO TOP OF
TO FDN TOP OF FOUNDATION
TOB TOP OF BEAM
TOM TOP OF MASONRY
TOP TOP OF PARAPET
TOS TOP OF STEEL
TOW TOP OF WALL
TPD TOILET PAPER DISPENSER
TPH TOILET PAPER HOLDER
TR TOWEL RACK
TRANS TRANSOM
TRANS WD FIN TRANSPARENT WOOD FINISH
TRTD TREATED
TS TENSILE STRENGTH OR TUBE
STEEL
TSTAT THERMOSTAT
TV TELEVISION
TYP TYPICAL
U HEAT TRANSFER COEFFICIENT
UC UNDERCUT
UCD UNDERCUT DOOR
UGND UNDERGROUND
UL UNDERWRITERS LABORATORIES
ULT ULTIMATE
UNFIN UNFINISH
UON UNLESS OTHERWISE NOTED
UPS UNINTERRUPTIBLE POWER SUPPLY
UR URINAL
UTIL UTILITY
UV ULTRAVIOLET
V VOLT
VAC VACUUM
VAR VARIES
VCT VINYL COMPOSITION TILE
VITRIFIED CLAY TILE
VEH VEHICLE
VENT VENTILATION
VERT VERTICAL
VEST VESTIBULE
VFAT VINYL FACED ACOUSTICAL TILE
VIC VICINITY
VID VIDEO
VIF VERIFY IN FIELD
VNR VENEER
VOC VOLATILE ORGANIC COMPOUND
VOL VOLUME
VOLT VOLTAGE
VP VENEER PLASTER
VR VAPOR RETARDER
VTR VENT THROUGH ROOF
VWC VINYL WALL COVERING
VWF VINYL WALL FABRIC
W WIDE OR WEST
WITH
W/O WITHOUT
WARR WARRANTY
WBL WOOD BLOCKING
WCL WALL COVERING OR WATER CLOSET
WC WL HNG WATER CLOSET, WALL HUNG
WCHR WATER CHILLER
WCL WL MTD WATER COOLER, WALL HUNG
WD WOOD
WDW WINDOW
WF WIDE FLANGE
WFB WALL FABRIC
WFR WOOD FRAME
WFS WOOD FURRING STRIPS
WH WATER HEATER
WHSE WAREHOUSE
WLD WELDED
WM WIRE MESH
WP WATERPROOFING
WPD WATER PRESSURE DROP
WPM WATERPROOF MEMBRANE
WR WEATHER RESISTANT
WS WEATHERSTRIP
WSCT WAINSCOT
WT WEIGHT
WWF WELDED WIRE FABRIC
X BRACE CROSS BRACE
XPS EXTRUDED POLYSTYRENE BOARD (INSULATION)
YD YARD
YR YEAR

| | |
|-------------------|------------|
| BIDDING DOCUMENTS | 03/27/2013 |
| Revisions: | Date: |



VA Northern Indiana
Health Care System,
Fort Wayne
2121 Lake Ave., Fort Wayne
IN 46805

CONSULTANTS:

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(219) 836-2120 Fax (219) 836-1129

Approved: Medical Center Director

NAME: _____

SIGNATURE: _____

Approved: Medical Center Associate Director

NAME: _____

SIGNATURE: _____

Drawing Title

ARCHITECTURAL ABBREVIATIONS

Approved: Engineering Service

NAME: _____

SIGNATURE: _____

Approved: Project Director

NAME: _____

SIGNATURE: _____

Project Title

Renovate First Floor East Wing
for PACT

Location

2121 Lake Ave., Fort Wayne, IN 46805

Date

03/27/2013

Checked

DLW

Drawn

TKP

Project Number

610A4-12-107

Building Number

01

Drawing Number


GI-003

Dwg. 3 of 58

Office of
Construction
and Facilities
Management

Department of
Veterans Affairs

three inches = one foot
one and one half inches = one foot
one inch = one foot
three quarters inch = one foot
one half inch = one foot
three eighths inch = one foot
one quarter inch = one foot
one eighth inch = one foot

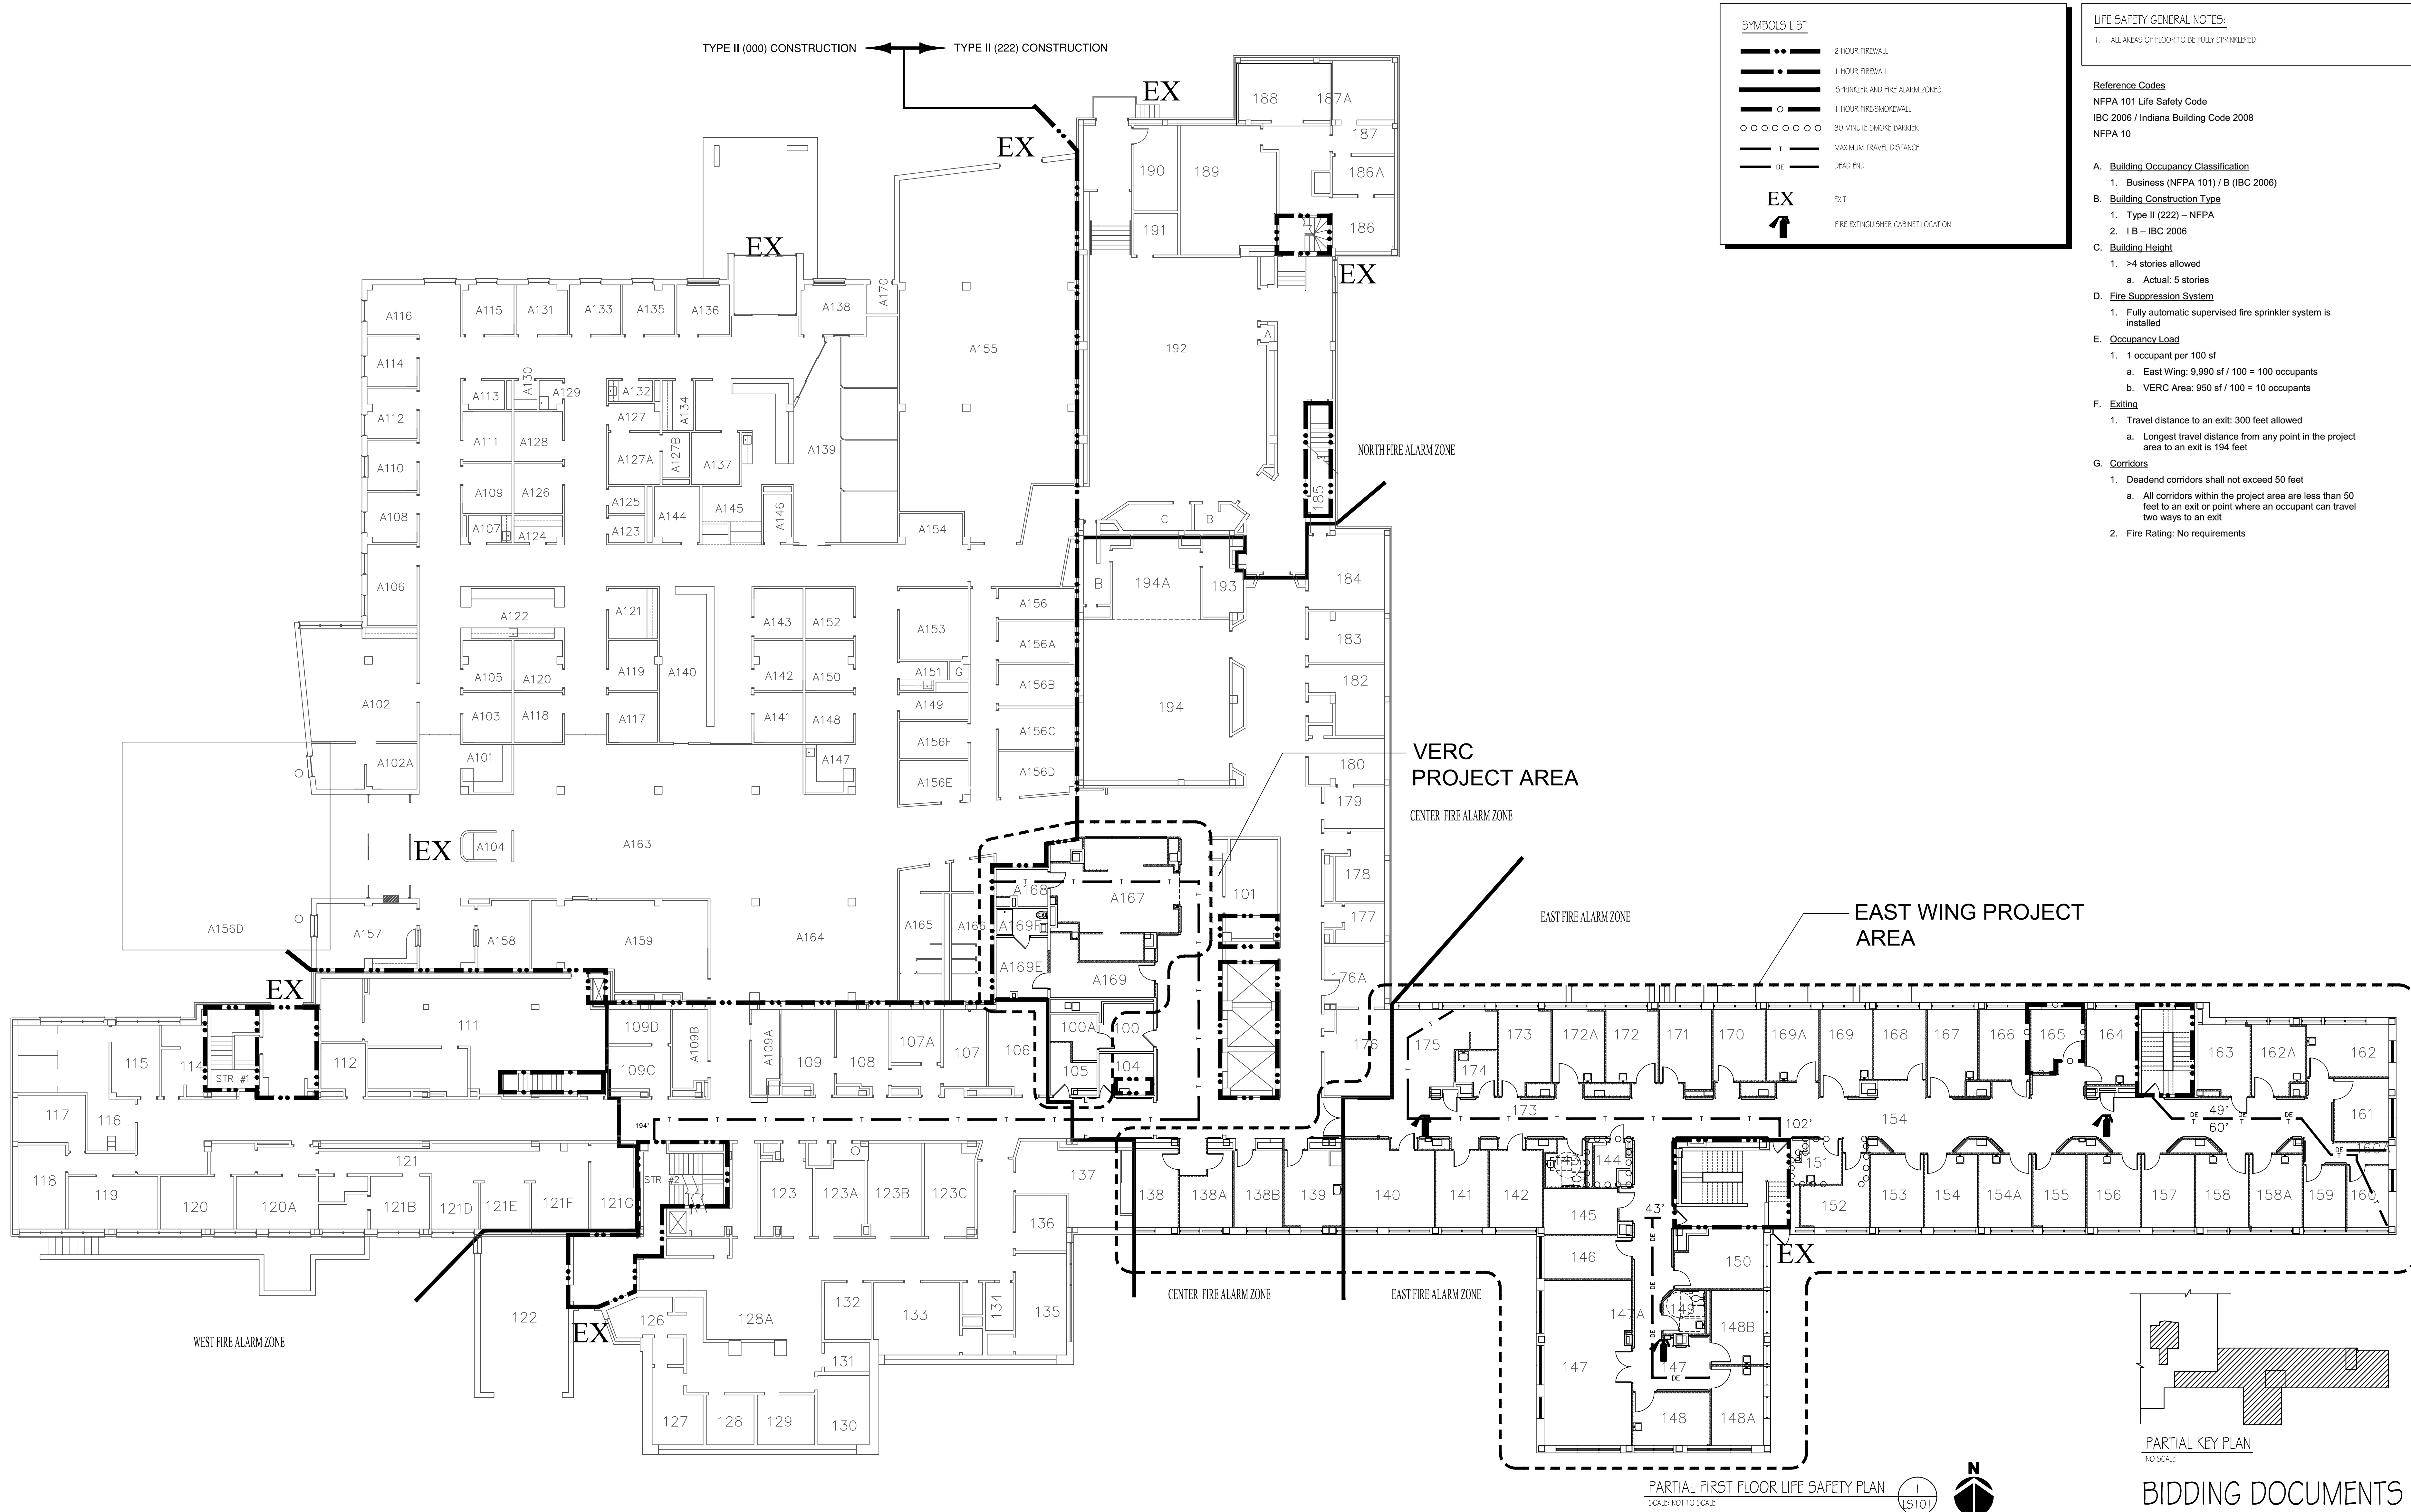

SYMBOLS LIST

- 2 HOUR FIREWALL
- 1 HOUR FIREWALL
- SPRINKLER AND FIRE ALARM ZONES
- 1 HOUR FIREWALL
- 30 MINUTE SMOKE BARRIER
- MAXIMUM TRAVEL DISTANCE
- DEAD END
- EXIT
- FIRE EXTINGUISHER CABINET LOCATION

LIFE SAFETY GENERAL NOTES:

1. ALL AREAS OF FLOOR TO BE FULLY SPRINKLERED.

Reference Codes

NFPA 101 Life Safety Code
IBC 2006 / Indiana Building Code 2008
NFPA 10

A. Building Occupancy Classification

1. Business (NFPA 101) / B (IBC 2006)

B. Building Construction Type

1. Type II (222) - NFPA
2. I-B - IBC 2006

C. Building Height

1. >4 stories allowed
a. Actual: 5 stories

D. Fire Suppression System

1. Fully automatic supervised fire sprinkler system is installed

E. Occupancy Load

1. 1 occupant per 100 sf
a. East Wing: 9,990 sf / 100 = 100 occupants
b. VERC Area: 950 sf / 100 = 10 occupants





F. Exiting

1. Travel distance to an exit: 300 feet allowed
a. Longest travel distance from any point in the project area to an exit is 194 feet

G. Corridors

1. Deadend corridors shall not exceed 50 feet
a. All corridors within the project area are less than 50 feet to an exit or point where an occupant can travel two ways to an exit

2. Fire Rating: No requirements

| | | | | | | | |
|--|--|--|--|---|--|--|---|
|  VA Northern Indiana Health Care System, Fort Wayne 2121 Lake Ave., Fort Wayne IN 46805 | CONSULTANTS: USFin Development, LLC 1105 West Weir Street Litchfield, Illinois 62556 Viridian Architectural Design, Inc. 2020 East Washington Blvd, Suite 200 Fort Wayne, Indiana 46803 | ARCHITECT/ENGINEERS:  AMERICAN STRUCTUREPOINT INC. 7280 SHADELAND STATION INDIANAPOLIS, IN 46256-3957 TEL 317.547.5580 FAX 317.543.0270 www.structurepoint.com  EnerTronics ENERGY TO EXCEL Engineering Corporation The Fairmont Building 9245 Calumet Ave., Suite 205, Munster, IN 46321 (219) 836-2120 Fax (219) 836-1129 | Approved: Medical Center Director NAME: _____ SIGNATURE: _____ | Drawing Title PARTIAL FIRST FLOOR LIFE SAFETY PLAN | Project Title Renovate First Floor East Wing for PACT | Project Number 610A4-12-107 | Office of Construction and Facilities Management  |
| | | | Approved: Medical Center Associate Director NAME: _____ SIGNATURE: _____ | Approved: Engineering Service NAME: _____ SIGNATURE: _____ | Approved: Project Director NAME: _____ SIGNATURE: _____ | Location 2121 Lake Ave., Fort Wayne, IN 46805 | |

VA FORM 08-6231

A

B

C

D

E

F

A

B

C

D

E

F

three inches = one foot
6"

one and one half inches = one foot
6"

one inch = one foot
6"


three quarters inch = one foot
6"

one half inch = one foot
6"


three eighths inch = one foot
6"

one quarter inch = one foot
6"

one eighth inch = one foot
6"

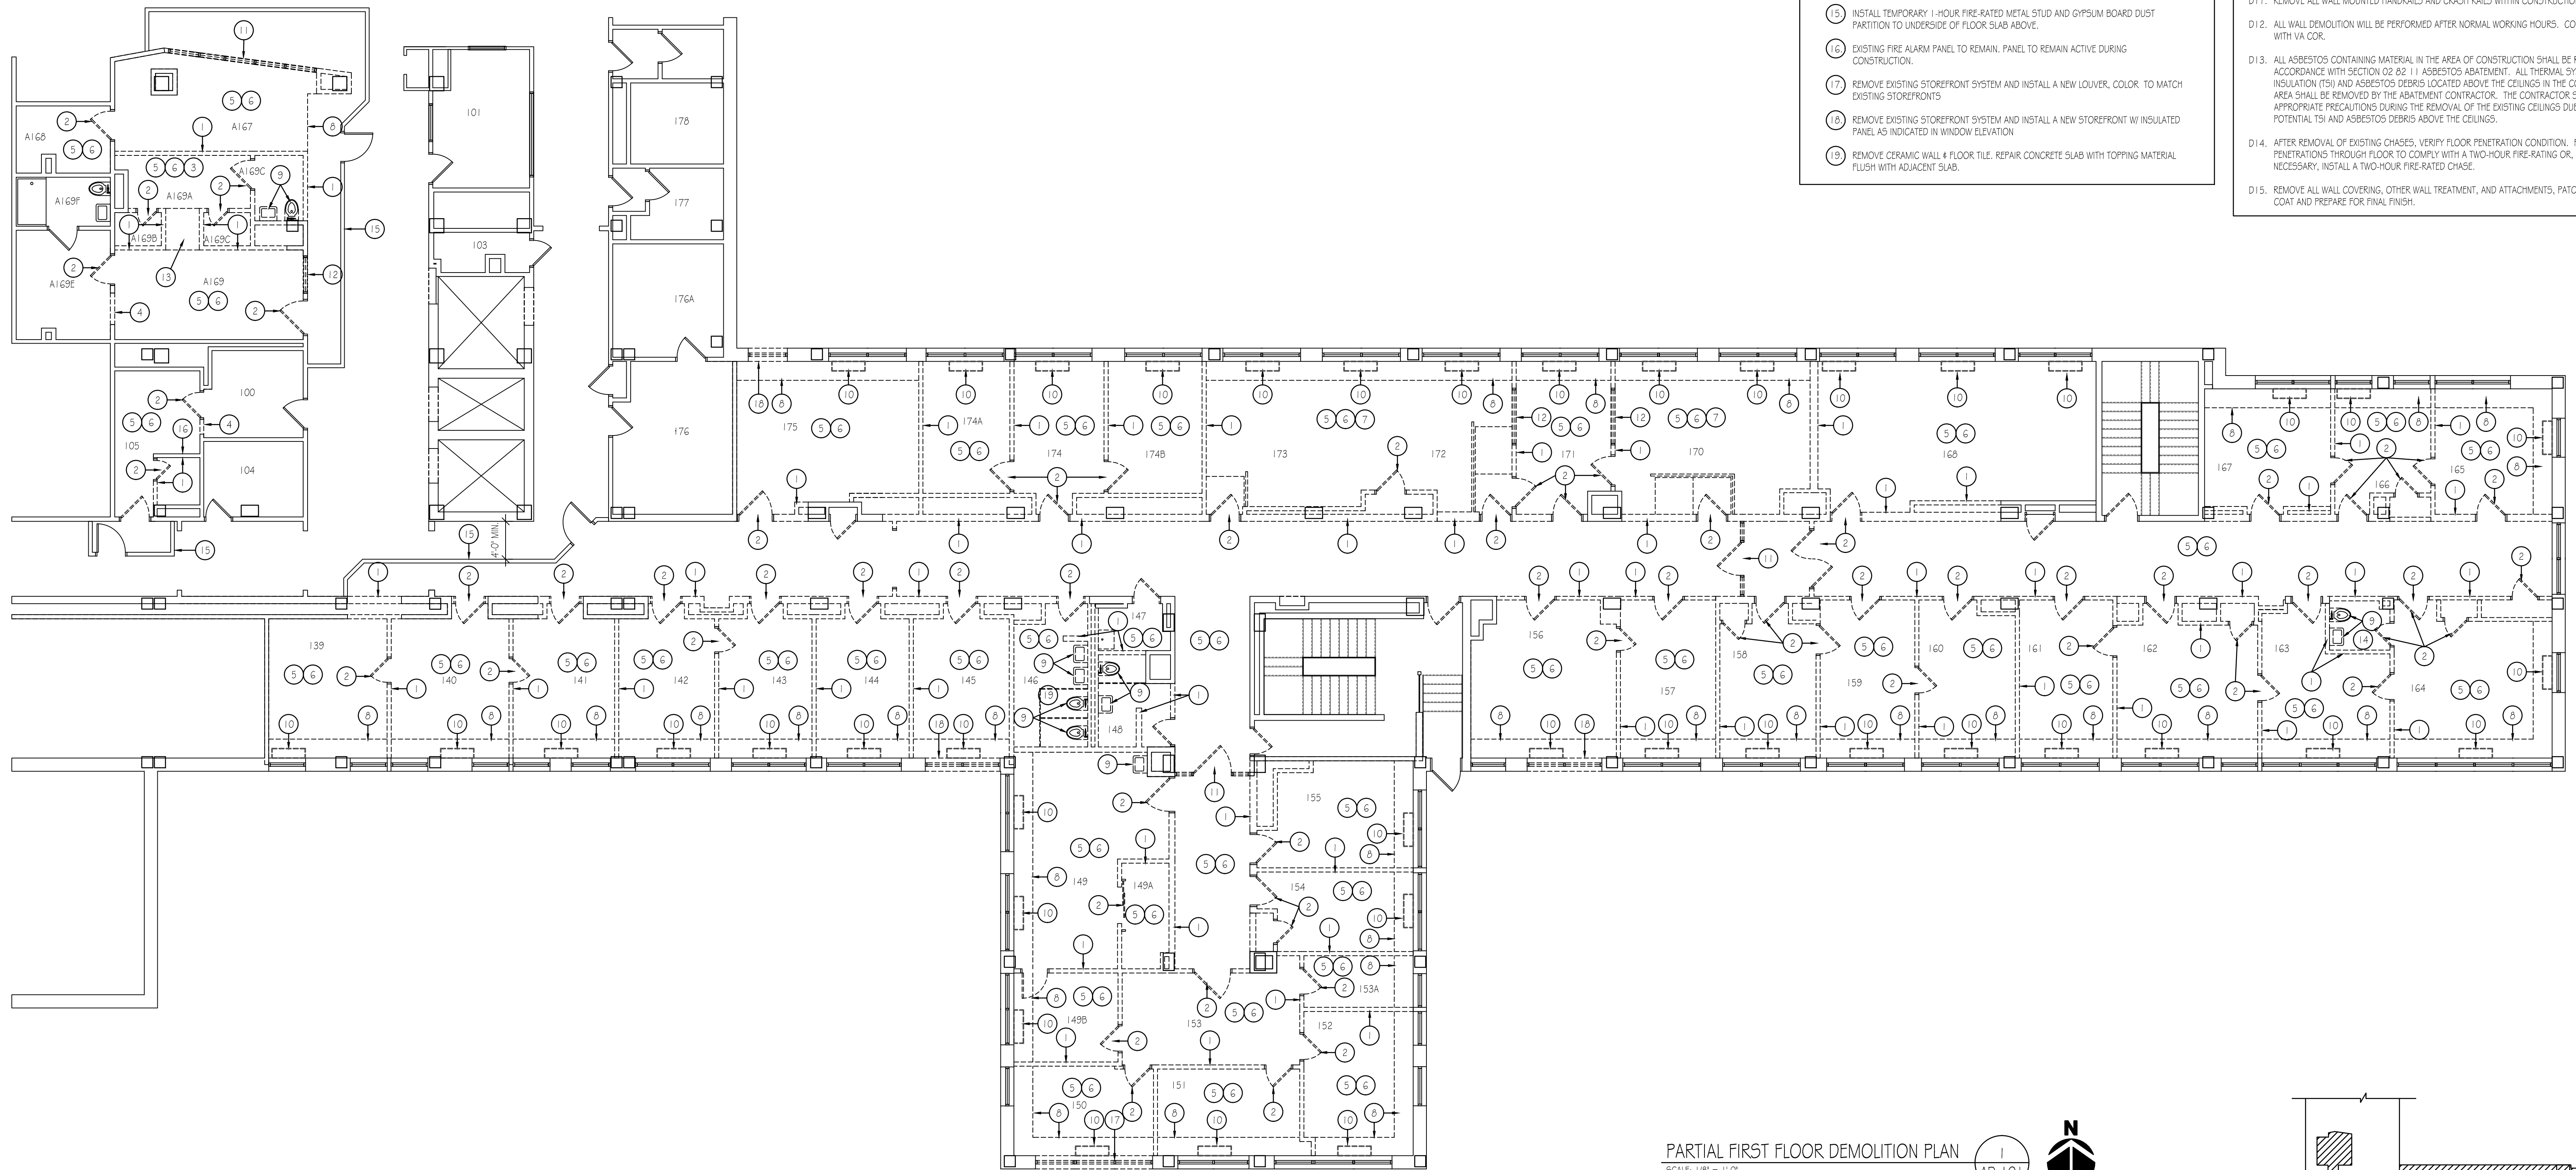

PARTIAL FIRST FLOOR DEMOLITION PLAN
SCALE: 1/8" = 1'-0"

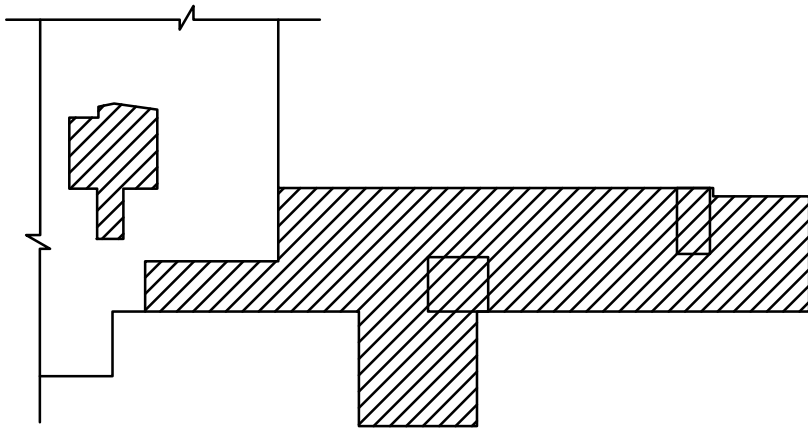


PARTIAL KEY PLAN
NO SCALE

BIDDING DOCUMENTS FULLY SPRINKLERED

| | | | | | | | | | | | | | | | | | |
|--|--|--|--|---|--|--|--|--|--|--|--|---|--|---|--|---|--|
| BIDDING DOCUMENTS 03/27/2013 Date | | VA Northern Indiana Health Care System, Fort Wayne 2121 Lake Ave., Fort Wayne IN 46805 | | CONSULTANTS: USFin Development, LLC 1105 West Weir Street Litchfield, Illinois 62556 Viridian Architectural Design, Inc. 2020 East Washington Blvd., Suite 200 Fort Wayne, Indiana 46803 | | ARCHITECT/ENGINEERS: AMERICAN STRUCTUREPOINT INC. 7260 SHADELAND STATION INDIANAPOLIS, IN 46256-3957 TEL 317-547-5580 FAX 317-543-0270 www.structurepoint.com Engineering Corporation The Farmington Building 3245 Calumet Ave., Suite 205, Munster, IN 46321 (219) 836-2120 Fax (219) 836-1129 | | Approved: Medical Center Director NAME: _____ SIGNATURE: _____ Approved: Medical Center Associate Director NAME: _____ SIGNATURE: _____ | | Drawing Title PARTIAL FIRST FLOOR DEMOLITION PLAN Approved: Engineering Service NAME: _____ SIGNATURE: _____ Approved: Project Director NAME: _____ SIGNATURE: _____ | | Project Title Renovate First Floor East Wing for PACT Location 2121 Lake Ave., Fort Wayne, IN 46805 Date 03/27/2013 Checked DLW Drawn TKP | | Project Number 610A4-12-107 Building Number 01 Drawing Number AD-101 Dwg 5 of 58 | | Office of Construction and Facilities Management Department of Veterans Affairs | |
|--|--|--|--|---|--|--|--|--|--|--|--|---|--|---|--|---|--|

three inches = one foot
one and one half inches = one foot
one inch = one foot
three quarters inch = one foot
one half inch = one foot
one quarter inch = one foot
one eighth inch = one foot
one sixteenth inch = one foot

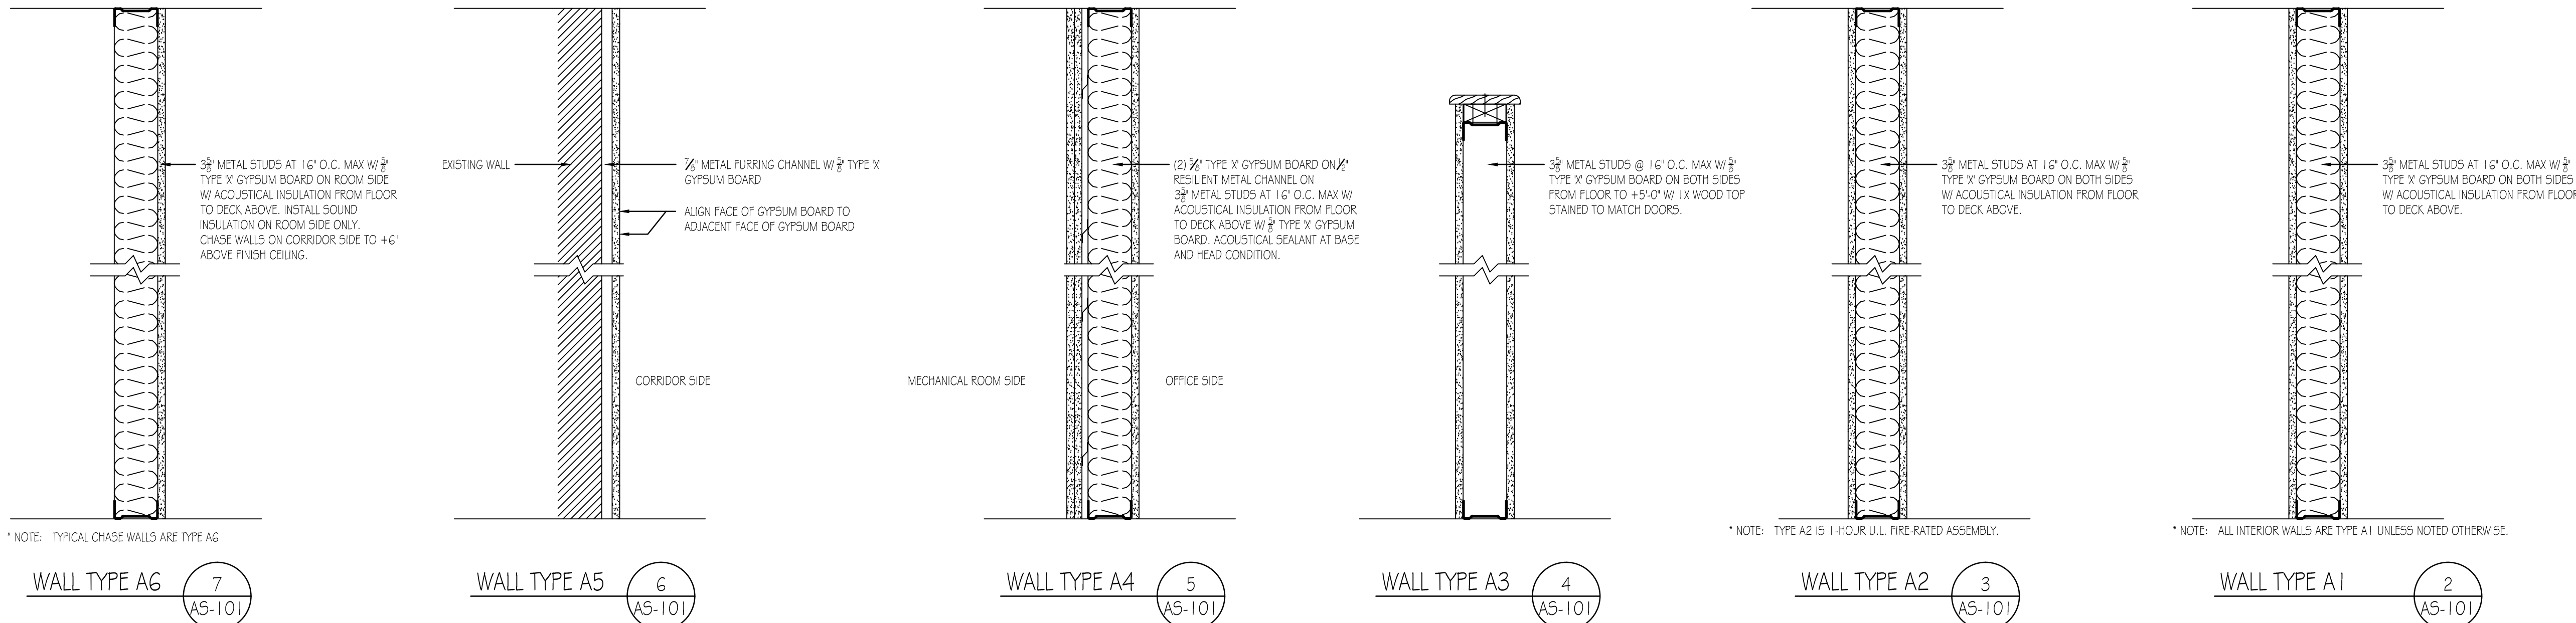

GENERAL NOTES, ALL CONTRACTORS

A. EXISTING CONDITIONS SHALL BE FIELD VERIFIED PRIOR TO BIDDING OR BEGINNING OF WORK. ANY ERRORS OR OMISSIONS SHALL BE BROUGHT TO THE ATTENTION OF THE ARCHITECT.

B. ALL ITEMS NOT SYMBOLIZED OR NOTED ARE EXISTING TO REMAIN.

B.1. CUTTING AND PATCHING: ALL OPENINGS REQUIRED IN NEW CONSTRUCTION FOR DUCTWORK, CONDUIT, ETC. SHALL BE BY G.C.

B.2. UNLESS OTHERWISE NOTED, ALL OPENINGS AND PATCH WORK REQUIRED IN EXISTING WALLS, FLOORS, ETC. FOR DUCTWORK, CONDUIT, ETC. SHALL BE BY RESPECTIVE MECHANICAL AND ELECTRICAL CONTRACTORS. MAINTAIN EXISTING MATERIAL, FINISH AND FIRE RATING AT WALLS TO BE PATCHED. COORDINATE WORK WITH G.C.

C. ANY WOOD SHALL BE FIRE RETARDANT OR NON-FIRE RETARDANT PAINTED WITH INTUMESCENT PAINT.

D. ALL WORK SHALL BE PERFORMED IN A SKILLED WORKMANSHIP TYPE MANNER ACCEPTABLE TO THE ARCHITECT AND OWNER.

E. PROVIDE SHEET METAL OR FIRE RETARDANT TREATED WOOD BLOCKING IN WALL CAVITIES FOR ITEMS THAT ARE REQUIRED TO BE SECURED TO THE WALLS, DOOR BUMPERS, CABINETS, SHELVING, ACCESSORIES, ETC.

F. ALL NEW INTERIOR FINISHES, INCLUDING FLOOR, WALL AND CEILING MATERIALS, SHALL BE IN ACCORDANCE WITH FLAME SPREAD AND SMOKE DEVELOPMENT REQUIREMENTS OF THE CURRENT EDITION OF NFPA 101 - LIFE SAFETY CODE.

GENERAL NOTES, GENERAL CONSTRUCTION

G1. THE GENERAL CONTRACTOR SHALL BE RESPONSIBLE FOR ALL PROJECT COORDINATION AND FOR PROVIDING ALL MATERIAL AND LABOR REQUIRED FOR THE COMPLETION OF THE PROJECT.

G2. TAPE AND SPACKLE ALL PENETRATIONS IN GYPSUM BOARD PARTITIONS, INCLUDING WATER LINES, DRAINS, CONDUIT, THERMOSTATS. INSTALL FIRE RETARDANT SEALANT AT PENETRATIONS IN RATED PARTITIONS.

G3. PROVIDE LATEX UNDERLAYMENT AT ALL DEPRESSIONS IN EXISTING FLOOR SLAB AND FLUSH WITH TOP OF EXISTING ADJACENT FLOOR.


G4. DIMENSIONS SHOWN ARE TO FACE OF STUD ON NEW PARTITIONS AND FINISHED FACE OF EXISTING PARTITIONS, U.N.O.







G5. DISTANCE FROM EDGE OF DOOR JAMB AT HINGE SIDE TO FACE OF ADJACENT WALL SHALL BE 4" UNLESS OTHERWISE NOTED.

G6. INSTALL CORNER GUARDS (TOP OF BASE TO CEILING), HANDRAIL AND CRASH RAIL WHERE INDICATED ON EQUIPMENT PLANS.

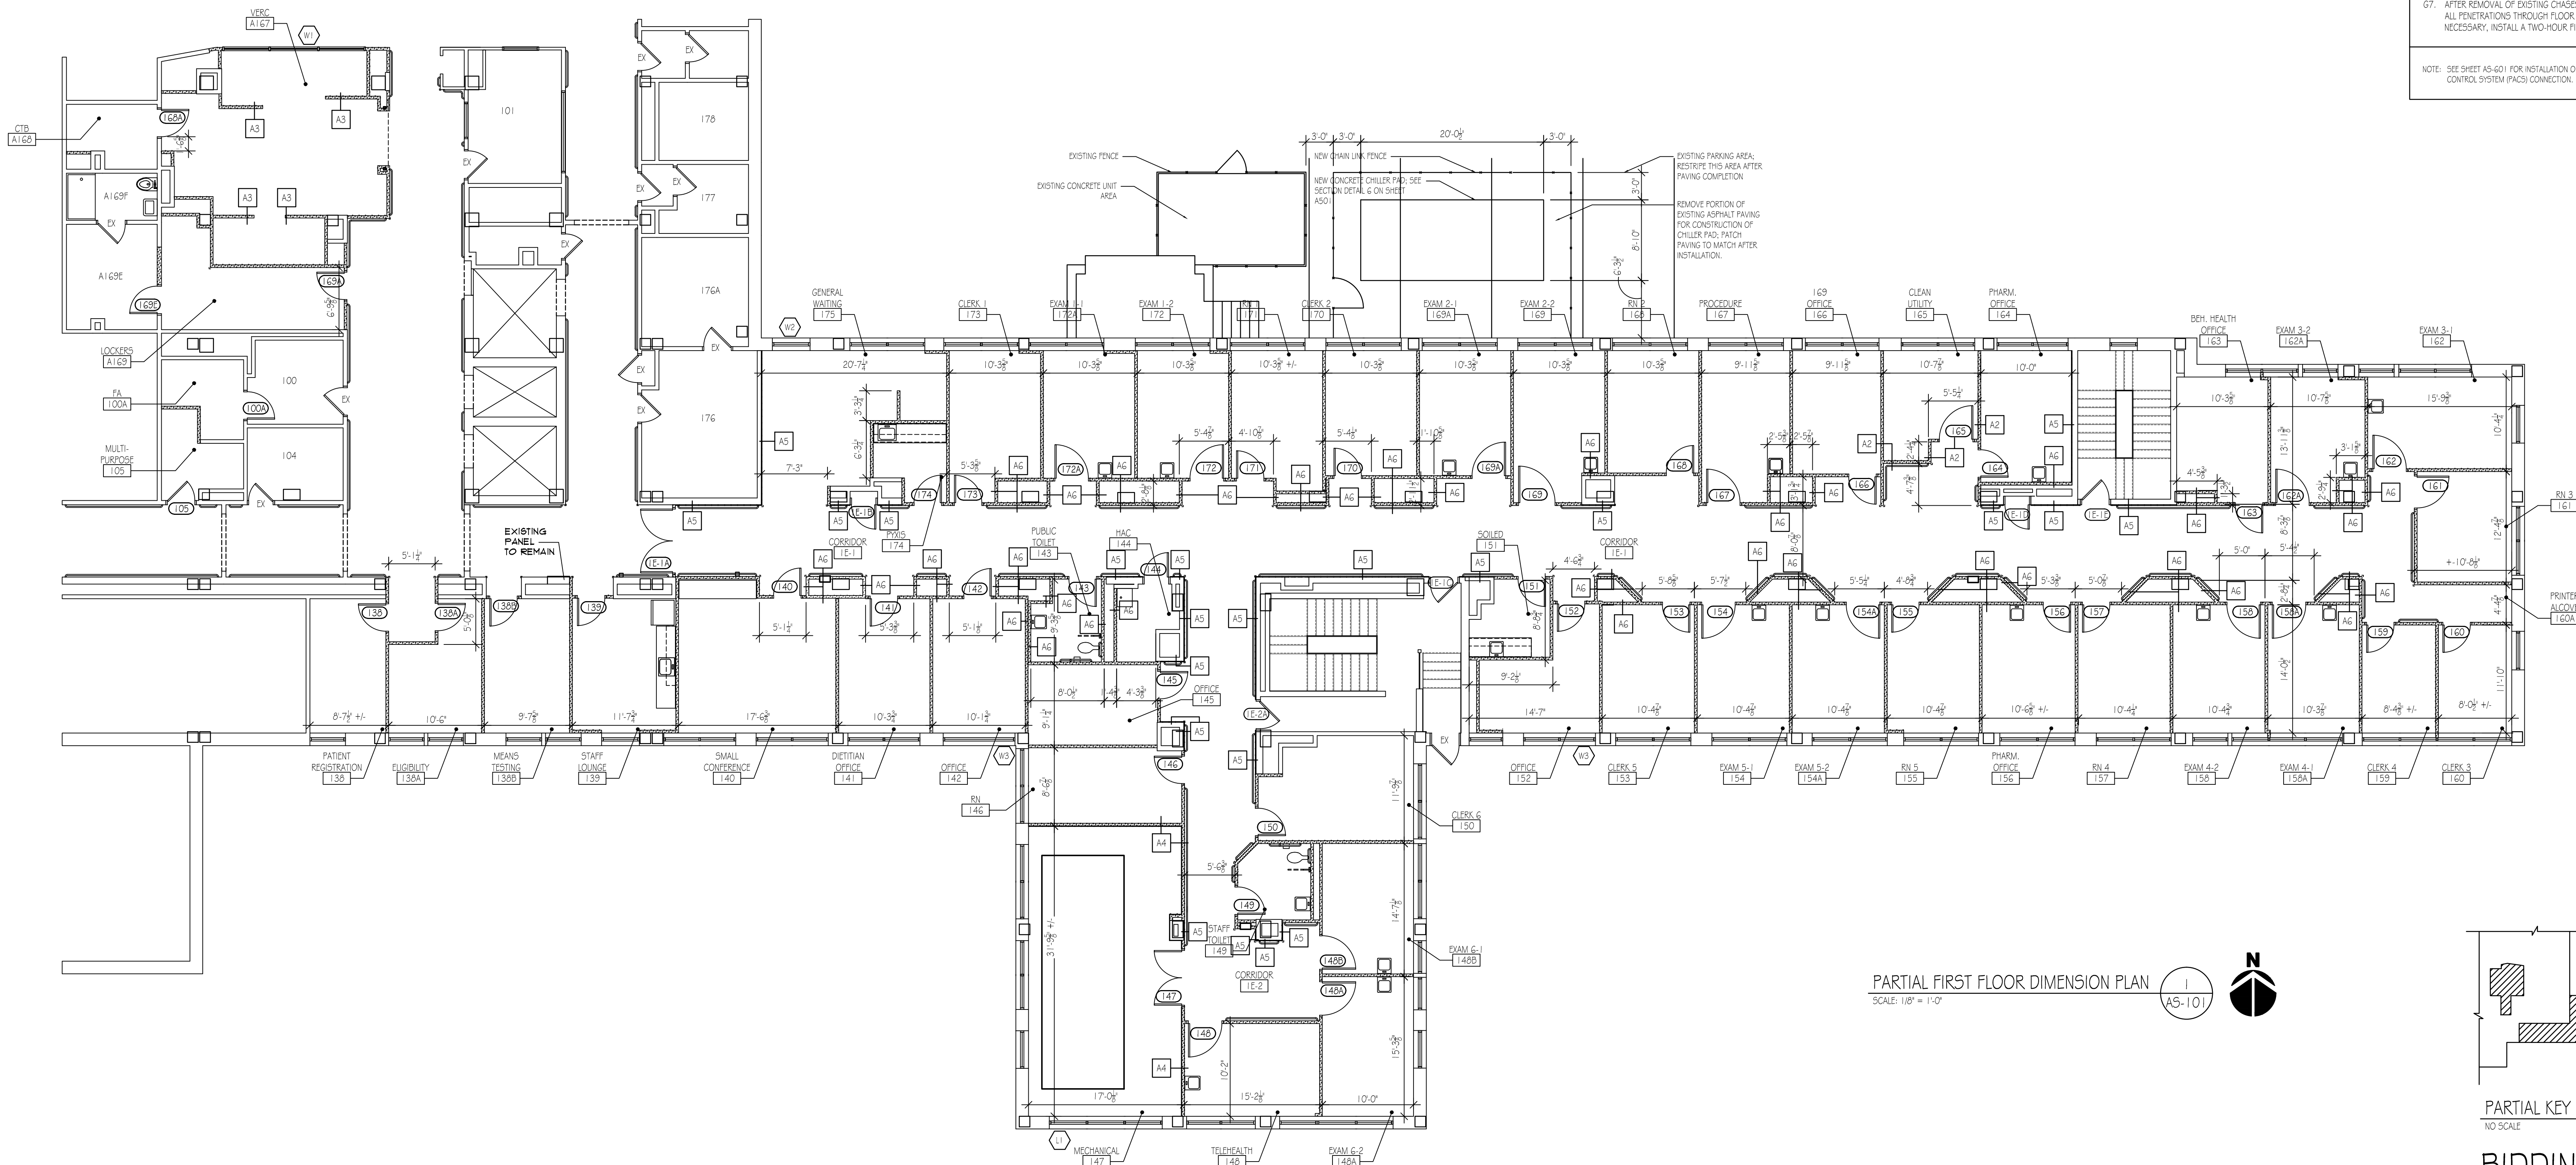
G7. AFTER REMOVAL OF EXISTING CHASES, VERIFY FLOOR PENETRATION CONDITION. FIRE STOP ALL PENETRATIONS THROUGH FLOOR TO COMPLY WITH A TWO-HOUR FIRE-RATING OR, IF NECESSARY, INSTALL A TWO-HOUR FIRE-RATED CHASE.

* NOTE: SEE SHEET AS-601 FOR INSTALLATION OF CONDUIT AT DOOR FRAMES FOR FUTURE PHYSICAL ACCESS CONTROL SYSTEM (PACS) CONNECTION.


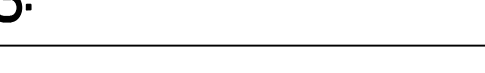


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|---|--|---|---|---|---|--|--|---|---|
| <div><div>VA Northern Indiana Health Care System, Fort Wayne 2121 Lake Ave., Fort Wayne IN 46805</div></div> | | <div>CONSULTANTS:<div>USFin Development, LLC 1105 West Weir Street Litchfield, Illinois 62056</div><div>Viridian Architectural Design, Inc. 2020 East Washington Blvd., Suite 200 Fort Wayne, Indiana 46803</div></div> | <div>ARCHITECT/ENGINEERS:<div><div><div>AMERICAN STRUCTUREPOINT INC. 7280 SHADELAND STATION INDIANAPOLIS, IN 46256-3957 TEL 317.547.5580 FAX 317.543.0270 www.structurepoint.com</div></div><div><div>Engineering Corporation The Farmington Building 9545 Galleries Ave., Suite 205, Munster, IN 46321 (219) 836-2120 Fax (219) 836-1129</div></div></div></div> <tr><td colspan="2"><div>Approved: Medical Center Director NAME: _____ SIGNATURE: _____</div><div>Approved: Medical Center Associate Director NAME: _____ SIGNATURE: _____</div></td><td><div>Drawing Title PARTIAL FIRST FLOOR DIMENSION PLAN</div><div>Approved: Engineering Service NAME: _____ SIGNATURE: _____</div><div>Approved: Project Director NAME: _____ SIGNATURE: _____</div></td><td><div>Project Title Renovate First Floor East Wing for PACT</div><div>Location 2121 Lake Ave., Fort Wayne, IN 46805</div><div>Date 03/27/2013</div><div>Checked DLW</div><div>Drawn TKP</div></td><td><div>Project Number 610A4-12-107</div><div>Building Number 01</div><div>Drawing Number AS-101 Dwg 6 of 58</div></td><td><div>Office of Construction and Facilities Management</div><div> Department of Veterans Affairs</div></td></tr> | <div>Approved: Medical Center Director NAME: _____ SIGNATURE: _____</div> <div>Approved: Medical Center Associate Director NAME: _____ SIGNATURE: _____</div> | | <div>Drawing Title PARTIAL FIRST FLOOR DIMENSION PLAN</div> <div>Approved: Engineering Service NAME: _____ SIGNATURE: _____</div> <div>Approved: Project Director NAME: _____ SIGNATURE: _____</div> | <div>Project Title Renovate First Floor East Wing for PACT</div> <div>Location 2121 Lake Ave., Fort Wayne, IN 46805</div> <div>Date 03/27/2013</div> <div>Checked DLW</div> <div>Drawn TKP</div> | <div>Project Number 610A4-12-107</div> <div>Building Number 01</div> <div>Drawing Number AS-101 Dwg 6 of 58</div> | <div>Office of Construction and Facilities Management</div> <div> Department of Veterans Affairs</div> |
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three inches = one foot
one and one half inches = one foot
one inch = one foot
three quarters inch = one foot
one half inch = one foot
three eighths inch = one foot
one quarter inch = one foot
one eighth inch = one foot

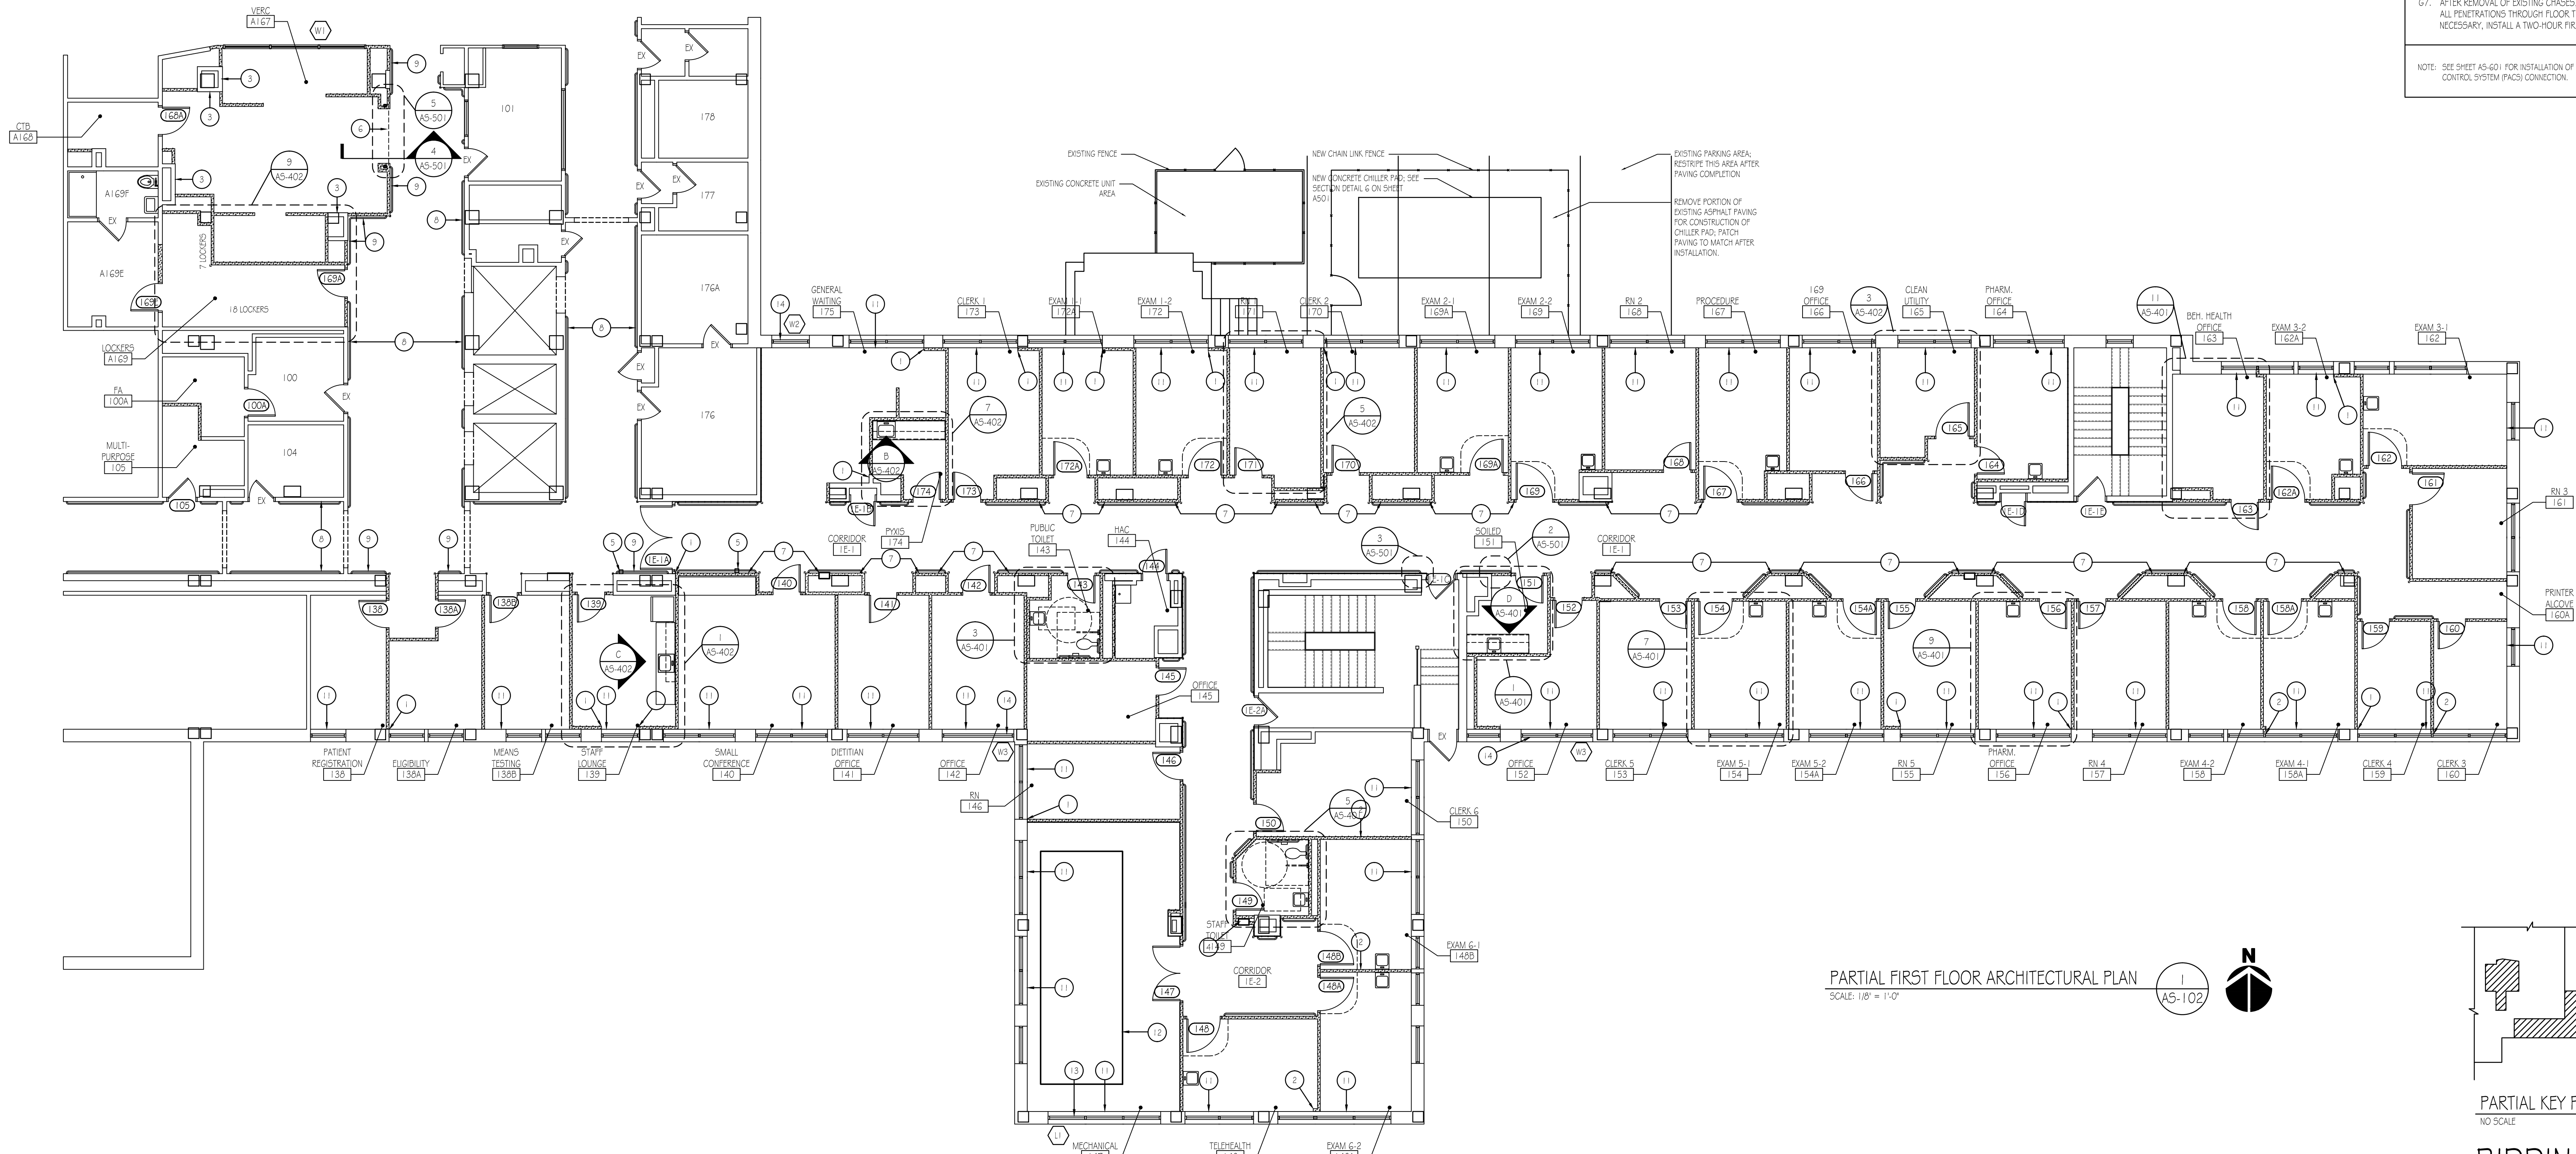

PARTIAL FIRST FLOOR ARCHITECTURAL PLAN
SCALE: 1/8" = 1'-0"

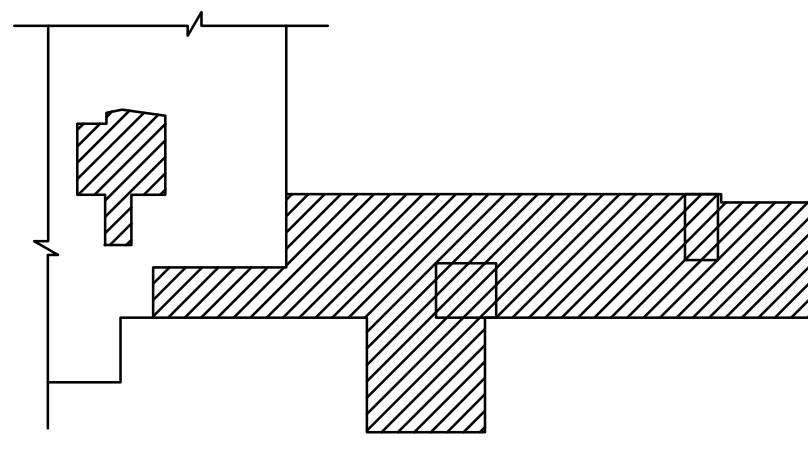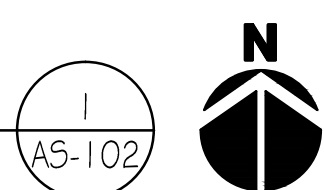

PARTIAL KEY PLAN
NO SCALE

BIDDING DOCUMENTS FULLY SPRINKLERED

| | | | | | | | | | | | | | | | | | |
|--|--|--|--|--|--|---|--|--|--|---|--|---|--|---|--|---|--|
| BIDDING DOCUMENTS 03/27/2013 Revisions: _____ Date: _____ | | VA Northern Indiana Health Care System, Fort Wayne 2121 Lake Ave., Fort Wayne IN 46805 | | CONSULTANTS: USFin Development, LLC 1105 West Weir Street Litchfield, Illinois 62556 Viridian Architectural Design, Inc. 2020 East Washington Blvd, Suite 200 Fort Wayne, Indiana 46803 | | ARCHITECT/ENGINEERS: AMERICAN STRUCTUREPOINT INC. 7280 SHADELAND STATION INDIANAPOLIS, IN 46256-9957 TEL 317.547.5580 FAX 317.543.0270 www.structurepoint.com enerTronics Engineering Corporation The Paramount Building 92445 Calumet Ave., Suite 205, Munster, IN 46321 (219) 836-2120 Fax (219) 836-1129 | | Approved: Medical Center Director NAME: _____ SIGNATURE: _____ Approved: Medical Center Associate Director NAME: _____ SIGNATURE: _____ | | Drawing Title PARTIAL FIRST FLOOR ARCHITECTURAL PLAN Approved: Engineering Service NAME: _____ SIGNATURE: _____ Approved: Project Director NAME: _____ SIGNATURE: _____ | | Project Title Renovate First Floor East Wing for PACT Location 2121 Lake Ave., Fort Wayne, IN 46805 Date 03/27/2013 Checked DLW Drawn TKP | | Project Number 610A4-12-107 Building Number 01 Drawing Number AS-102 Dwg 7 of 58 | | Office of Construction and Facilities Management Department of Veterans Affairs | |
|--|--|--|--|--|--|---|--|--|--|---|--|---|--|---|--|---|--|

- FLOOR PLAN NOTES :**
1. ALIGN FINISHED FACE OF NEW WALL WITH THE EDGE OF EXISTING COLUMN, PARTITION AND/OR WINDOW.
 2. CENTER NEW PARTITION ON CENTERLINE OF WINDOW MULLION OR PARTITION. INSTALL BRACE METAL CLOSURE AT END OF PARTITION.
 3. ADHERE 5/8" GYPSUM BOARD TO EXISTING PARTITION.
 4. NEW RECESSED FIRE EXTINGUISHER CABINET.
 5. PUSH PAD FOR AUTOMATIC DOOR OPENER. SEE DOOR HARDWARE SPECIFICATION AND ELECTRICAL SHEETS.
 6. NEW OVERHEAD COILING SECURITY GRILLE. 6'-0" W X 8'-0" H.
 7. ALIGN ALL CORRIDOR WALLS.
 8. EXISTING HANDRAILS TO REMAIN.
 9. NEW HANDRAIL TO MATCH EXISTING.
 10. NEW LOUVER BY M.C. COORDINATE WITH M.C. FOR OPENING PREP.
 11. INFILL VOID IN EXTERIOR WALL AFTER REMOVAL OF RADIATOR GRILLES (REF. MECH. DEMOLITION PLAN) WITH METAL STUDS AND UNFACED FIBERGLASS INSULATION. INSTALL CEMENT BACKER BOARD AND PLASTER FLUSH WITH EXISTING WALL. FOR PTAC OPENING INFILL - REF. DETAIL 1/AS-501.
 12. MECHANICAL CURB TO RECEIVE SKIRT COVER FOR DUST CONTROL.
 13. REMOVE EXISTING STOREFRONT SYSTEM AND INSTALL A NEW LOUVER, COLOR TO MATCH EXISTING STOREFRONTS - REF. DETAILS H5A5-602, J5A5-602, AND S5A5-602.
 14. REMOVE EXISTING STOREFRONT SYSTEM AND INSTALL A NEW STOREFRONT W/ INSULATED PANEL AS INDICATED IN WINDOW ELEVATION - REF. DETAILS H5A5-602, J5A5-602, AND S5A5-602.

- GENERAL NOTES, ALL CONTRACTORS**
- A. EXISTING CONDITIONS SHALL BE FIELD VERIFIED PRIOR TO BIDDING OR BEGINNING OF WORK. ANY ERRORS OR OMISSIONS SHALL BE BROUGHT TO THE ATTENTION OF THE ARCHITECT.
- B. ALL ITEMS NOT SYMBOLIZED OR NOTED ARE EXISTING TO REMAIN.
- B.1. CUTTING AND PATCHING: ALL OPENINGS REQUIRED IN NEW CONSTRUCTION FOR DUCTWORK, CONDUIT, ETC. SHALL BE BY G.C.
- B.2. UNLESS OTHERWISE NOTED, ALL OPENINGS AND PATCH WORK REQUIRED IN EXISTING WALLS, FLOORS, ETC. FOR DUCTWORK, CONDUIT, ETC. SHALL BE BY RESPECTIVE MECHANICAL AND ELECTRICAL CONTRACTORS. MAINTAIN EXISTING MATERIAL, FINISH AND FIRE RATING AT WALLS TO BE PATCHED. COORDINATE WORK WITH G.C.
- C. ANY WOOD SHALL BE FIRE RETARDANT OR NON-FIRE RETARDANT PAINTED WITH INTUMESCENT PAINT.
- D. ALL WORK SHALL BE PERFORMED IN A SKILLED WORKMANSHIP TYPE MANNER ACCEPTABLE TO THE ARCHITECT AND OWNER.
- E. PROVIDE SHEET METAL OR FIRE RETARDANT TREATED WOOD BLOCKING IN WALL CAVITIES FOR ITEMS THAT ARE REQUIRED TO BE SECURED TO THE WALLS, DOOR BUMPERS, CABINETS, SHELVING, ACCESSORIES, ETC.
- F. ALL NEW INTERIOR FINISHES, INCLUDING FLOOR, WALL AND CEILING MATERIALS, SHALL BE IN ACCORDANCE WITH FLAME SPREAD AND SMOKE DEVELOPMENT REQUIREMENTS OF THE CURRENT EDITION OF NFPA 101 - LIFE SAFETY CODE.
- GENERAL NOTES, GENERAL CONSTRUCTION**
- G1. THE GENERAL CONTRACTOR SHALL BE RESPONSIBLE FOR ALL PROJECT COORDINATION AND FOR PROVIDING ALL MATERIAL AND LABOR REQUIRED FOR THE COMPLETION OF THE PROJECT.
- G2. TAPE AND SPACKLE ALL PENETRATIONS IN GYPSUM BOARD PARTITIONS, INCLUDING, BUT NOT LIMITED TO WATER LINES, DRAINS, CONDUIT, THERMOSTATS, ETC. INSTALL FIRE RETARDANT SEALANT AT PENETRATIONS IN RATED PARTITIONS.
- G3. PROVIDE LATEX UNDERLAYMENT AT ALL DEPRESSIONS IN EXISTING FLOOR SLAB AND FLUSH WITH TOP OF EXISTING ADJACENT FLOOR.
- G4. DIMENSIONS SHOWN ARE TO FACE OF STUD ON NEW PARTITIONS AND FINISHED FACE OF EXISTING PARTITIONS; U.N.O.
- G5. DISTANCE FROM EDGE OF DOOR JAMB AT HINGE SIDE TO FACE OF ADJACENT WALL SHALL BE 4" UNLESS OTHERWISE NOTED.
- G6. INSTALL CORNER GUARDS (TOP OF BASE TO CEILING), HANDRAIL AND CRASH RAIL WHERE INDICATED ON EQUIPMENT PLANS.
- G7. AFTER REMOVAL OF EXISTING CHASES, VERIFY FLOOR PENETRATION CONDITION. FIRE STOP ALL PENETRATIONS THROUGH FLOOR TO COMPLY WITH A TWO-HOUR FIRE-RATING OR, IF NECESSARY, INSTALL A TWO-HOUR FIRE-RATED CHASE.
- NOTE: SEE SHEET AS-601 FOR INSTALLATION OF CONDUIT AT DOOR FRAMES FOR FUTURE PHYSICAL ACCESS CONTROL SYSTEM (PACS) CONNECTION.

A

B

C

D

E

F

A


B

C

D

E

F

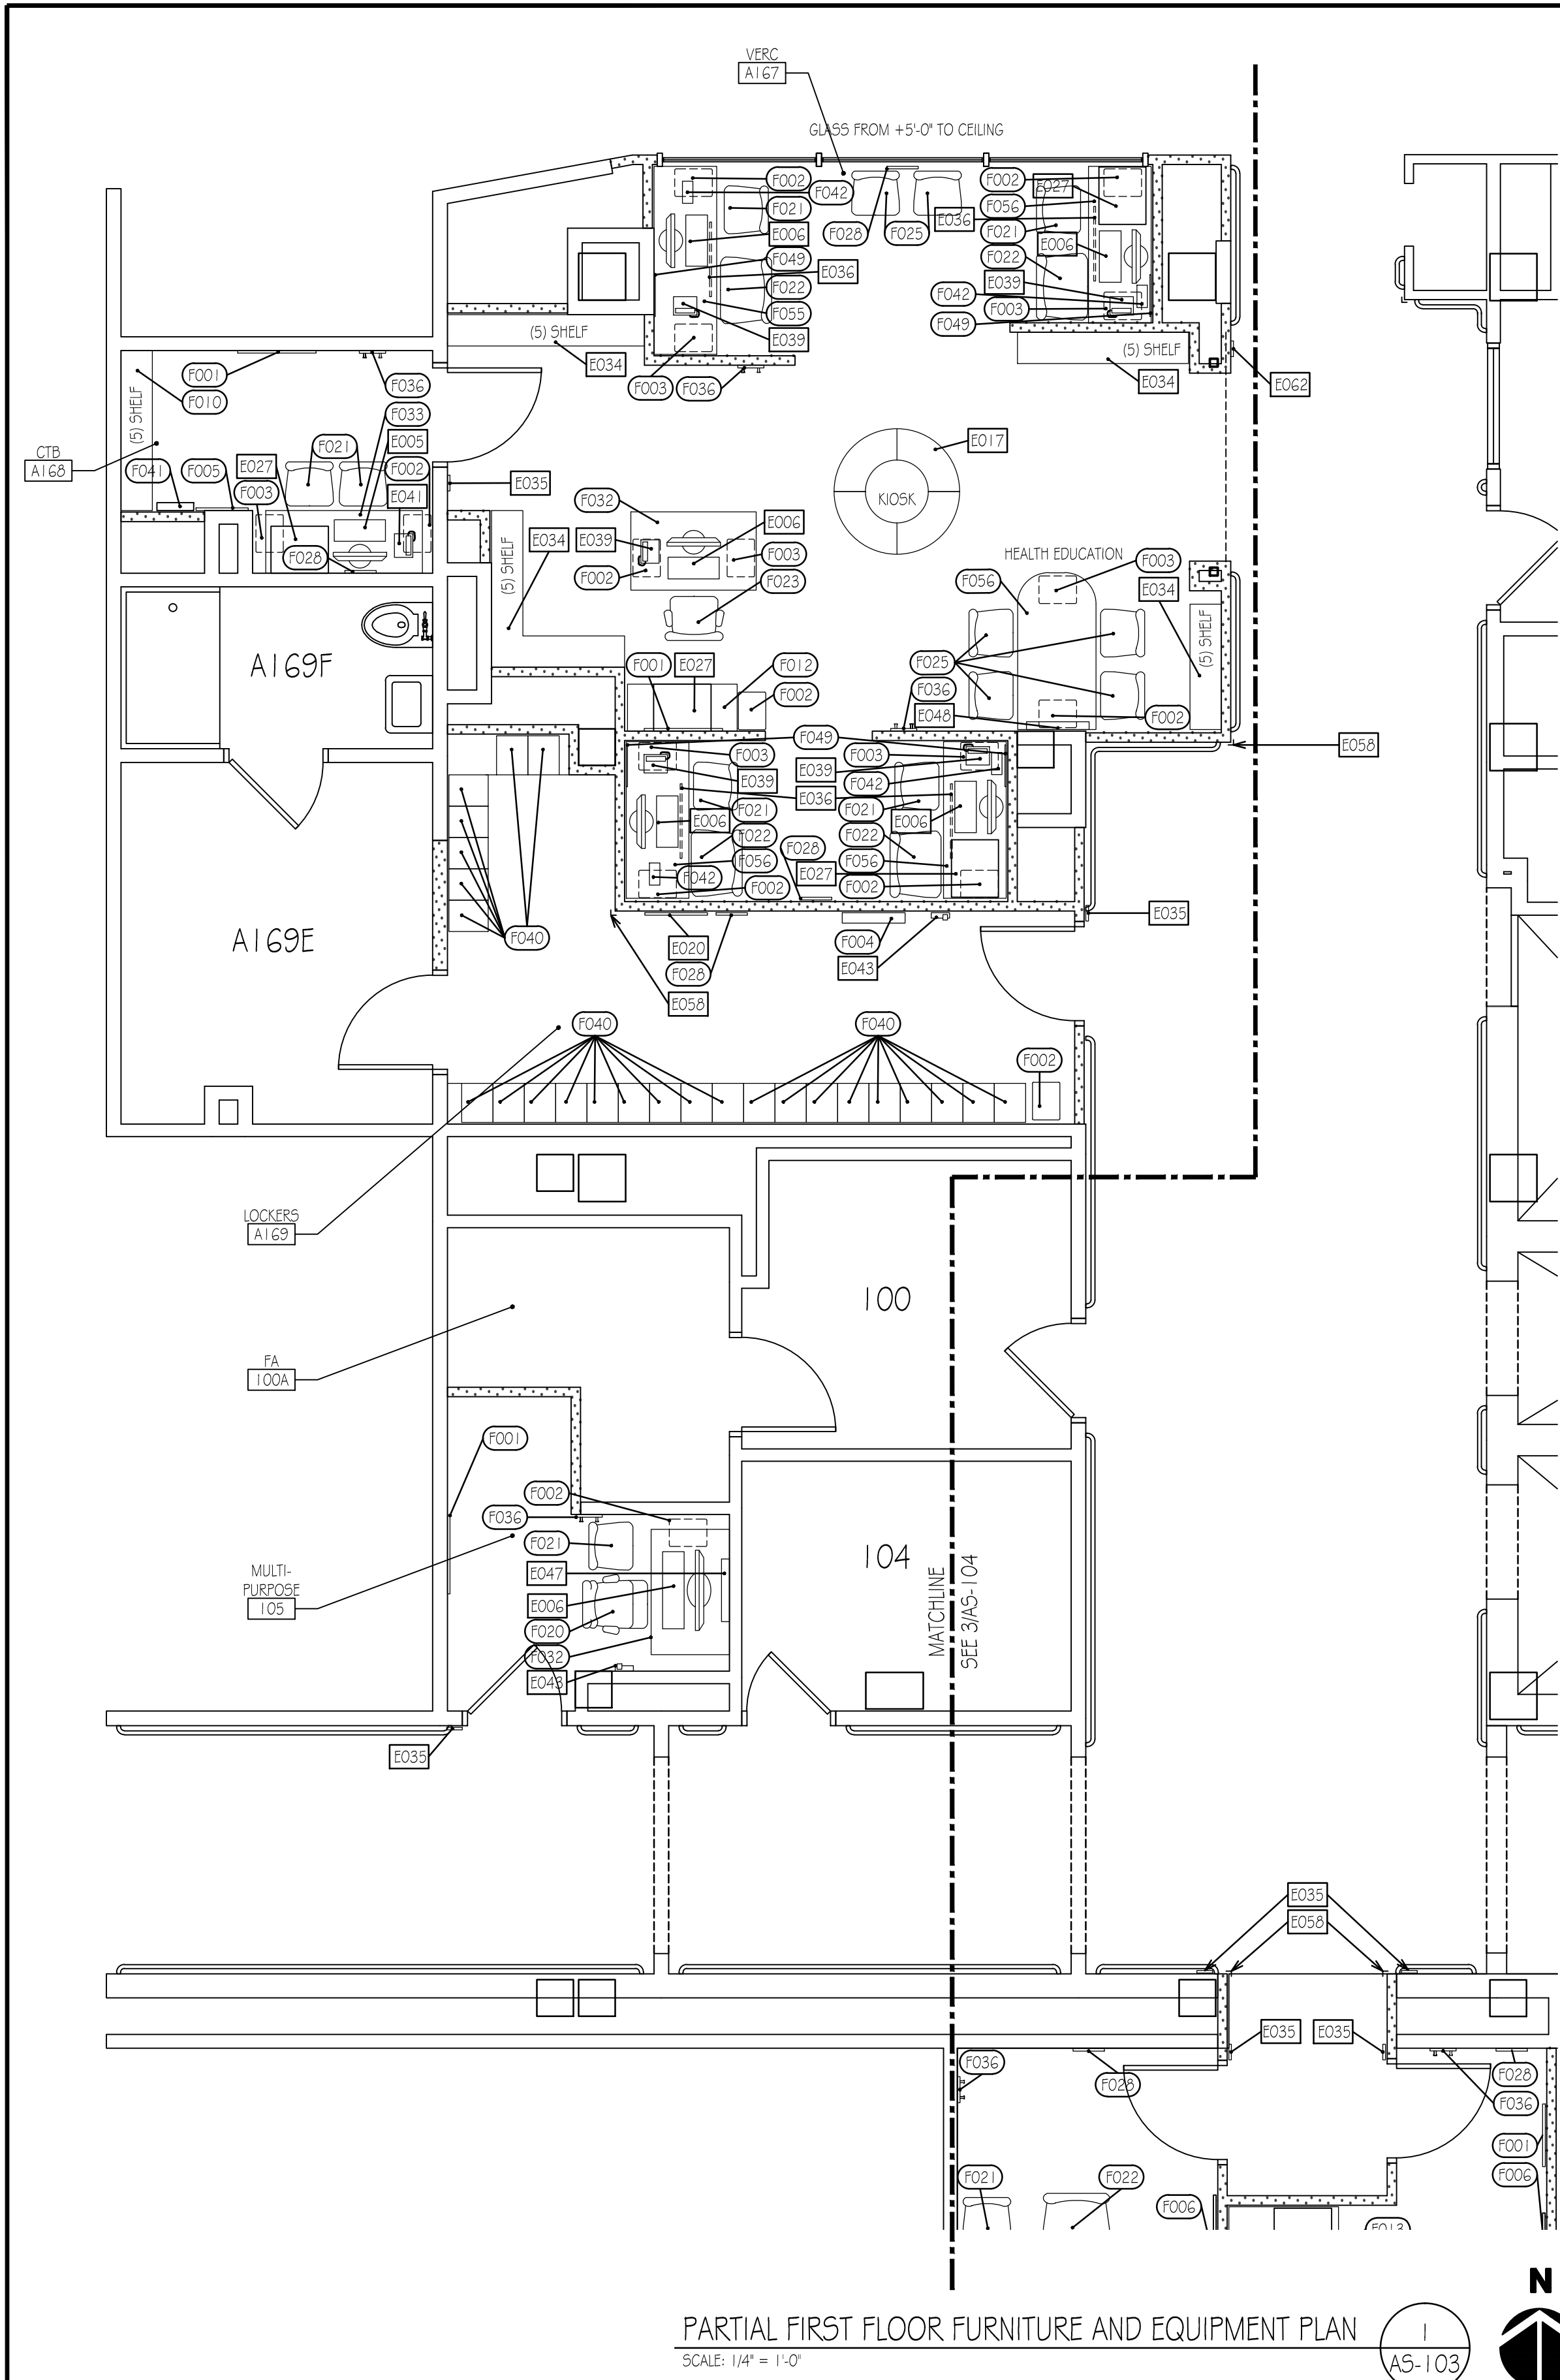

PARTIAL FIRST FLOOR FURNITURE AND EQUIPMENT PLAN
SCALE: 1/4" = 1'-0"

| FURNITURE SCHEDULE | | | | | | |
|--------------------|-----------------------------------|--|--|--------------|-------|-----------------|
| MARK (E001) | NEW (N) OR RELOCATED (R) | ITEM | CC = CONTRACTOR FURNISHED AND INSTALLED VC = VA FURNISHED - CONTRACTOR INSTALLED VD = VA FURNISHED - FURNITURE DEALER INSTALLED VV = VA FURNISHED AND INSTALLED | MANUFACTURER | MODEL | MODEL NUMBER |
| F001 | N | ARTWORK, DECORATIVE, WITH FRAME | VC | -- | -- | -- |
| F002 | N | BASKET, WASTEPAPER, RECTANGULAR 9 X 18, WASTE | VC | -- | -- | -- |
| F003 | N | BASKET, WASTEPAPER, RECTANGULAR 9 X 18, RECYCLING | VC | -- | -- | -- |
| F004 | N | BENCH, FLOOR MOUNTED, FOLDING | VC | -- | -- | -- |
| F005 | N | BOARD, BULLETIN, 16 X 20 | CC | -- | -- | -- |
| F006 | N | BOARD, BULLETIN, 48 X 48 | VC | -- | -- | -- |
| F007 | N | BOOKCASE, FULL HEIGHT | VC | -- | -- | -- |
| F008 | N | BRACKET, TELEVISION, WALL BACKING | CC | -- | -- | -- |
| F009 | N | BUCKET, MOP, WITH WRINGER, 26 QUART | VC | -- | -- | -- |
| F010 | N | BUILT-IN ADJUSTABLE SHELVING, 3 SHELF | VC | -- | -- | -- |
| F011 | N | CABINET, BASIC, PLASTIC LAMINATE | CC | -- | -- | -- |
| F012 | N | CABINET, LATERAL FILING, FULL HEIGHT, LOCKABLE | VC | -- | -- | -- |
| F013 | N | CABINET, LATERAL FILING, HALF HEIGHT, LOCKABLE | VC | -- | -- | -- |
| F014 | N | CABINET, LATERAL FILING, HALF HEIGHT, 18"D, 42"W, WITH COUNTERTOP | VC | -- | -- | -- |
| F015 | N | CABINET, LATERAL FILING, THREE QUARTER HEIGHT, LOCKABLE | VC | -- | -- | -- |
| F016 | N | CABINET, WALL, PLASTIC LAMINATE | CC | -- | -- | -- |
| F017 | N | CAN, TRASH, 44 GALLON | CC | -- | -- | -- |
| F018 | N | CHAIR, CONFERENCE ROOM, LOW BACK, WITH ARMS | VD | -- | -- | -- |
| F019 | N | CHAIR, DINING | VD | -- | -- | -- |
| F020 | N | CHAIR, PADDED LOUNGE, SWIVEL, ROCKING | VD | -- | -- | -- |
| F021 | N | CHAIR, SIDE, WITHOUT ARMS | VD | -- | -- | -- |
| F022 | N | CHAIR, SIDE, WITHOUT ARMS, BARBATIC | VD | -- | -- | -- |
| F023 | N | CHAIR, SWIVEL, HIGH BACK, WITH ARMS | VD | -- | -- | -- |
| F024 | N | CHAIR, SWIVEL, LOW BACK, WITH ARMS | VD | -- | -- | -- |
| F025 | N | CHAIR, SWIVEL, LOW BACK, WITHOUT ARMS | VD | -- | -- | -- |
| F026 | N | CHAIR, WAITING ROOM, SINGLE, BARBATIC | VD | -- | -- | -- |
| F027 | N | CHAIR, WAITING ROOM, SINGLE, BARBATIC | VD | -- | -- | -- |
| F028 | N | CLOCKS, 12" ROUND, BATTERY | CC | -- | -- | -- |
| F029 | N | COUNTERTOP, PLASTIC LAMINATE | CC | -- | -- | -- |
| F030 | N | CREDENZA, 72" | VC | -- | -- | -- |
| F031 | N | DESK, 36" | VD | -- | -- | -- |
| F032 | N | DESK, 48" | VD | -- | -- | -- |
| F033 | N | DESK, DOUBLE PEDESTAL (60X30) | VD | -- | -- | -- |
| F034 | N | DESK, SINGLE PEDESTAL (60X30) | VD | -- | -- | -- |
| F035 | N | DRY MARKER BOARD, 48 X 48 | VC | -- | -- | -- |
| F036 | N | HOOK, GARMENT, DOUBLE, SS, SURFACE MOUNTED | CC | -- | -- | -- |
| F037 | N | HAMPER, LINEN, MOBILE, WITH LID | CC | -- | -- | -- |
| F038 | N | LAMP, TABLE, WITH SHADE | VC | -- | -- | -- |
| F039 | N | LATERAL FILE, 2 DRAWER WITH COUNTERTOP | VC | -- | -- | -- |
| F040 | N | LOCKER, 2 PERSON, DOUBLE TIER | VC | -- | -- | -- |
| F041 | N | PAMPHLET DISPLAY, WALL MOUNTED, 3 - 4 SLOTS | VC | -- | -- | -- |
| F042 | N | PAMPHLET DISPLAY, COUNTER TOP, 3 - 4 SLOTS | VC | -- | -- | -- |
| F043 | N | RACK, MAGAZINE, WALL MOUNTED | CC | -- | -- | -- |
| F044 | N | RACK, PAMPHLET, WALL MOUNTED | CC | -- | -- | -- |
| F045 | N | TABLE, CONFERENCE, 108 X 54 | VC | -- | -- | -- |
| F046 | N | TABLE, DINING, RECTANGULAR | VC | -- | -- | -- |
| F047 | N | TABLE, EXAMINATION/TREATMENT, WITH CABINET | VC | -- | -- | -- |
| F048 | N | TABLE, OCCASIONAL, 30X30 | VC | -- | -- | -- |
| F049 | N | TACK BOARD, 16X20 | VC | -- | -- | -- |
| F050 | N | TACK BOARD, 18X24 | VC | -- | -- | -- |
| F051 | N | TACK BOARD, 48 X 48, 1/2 DRY MARKER, 1/2 TACK | VC | -- | -- | -- |
| F052 | N | TACK BOARD, BETWEEN DESK AND UPPER STORAGE | VC | -- | -- | -- |
| F053 | N | TACK BOARD, BETWEEN TACK BOARD AND UPPER, 1/2 DRY MARKER, 1/2 TACK | VC | -- | -- | -- |
| F054 | N | TRACK CURTAIN | VC | -- | -- | -- |
| F055 | N | WORKSTATION, DESK 72X30 | VC | -- | -- | -- |
| F056 | N | WORKSTATION, DESK 60X30 | VC | -- | -- | -- |
| F057 | N | WORKSTATION, L SHAPED, 78 X 72, WITH FILE STORAGE, WALL UPPER STORAGE UNIT, LOCKABLE | VC | -- | -- | -- |
| F058 | N | WORKSTATION, RETRACTABLE, COMPUTER, WALL MOUNTED | VC | -- | -- | -- |
| F059 | N | STOOL, SELF ADJUSTING | VC | -- | -- | -- |

ROOM AND HANGFINDING INTERIOR SIGNAGE.
NOTE: ALL INTERIOR SIGNAGE SHALL BE PROVIDED BY AND INSTALLED BY THE CONTRACTOR. FOLLOW VA SIGNAGE GUIDELINES FOR LOCATIONS, HEIGHTS, AND REQUIREMENTS.

| EQUIPMENT SCHEDULE | | | | | | |
|--------------------|-----------------------------------|---|--|------------------------|-----------------------------|-----------------|
| MARK (E001) | NEW (N) OR RELOCATED (R) | ITEM | CC = CONTRACTOR FURNISHED AND INSTALLED VC = VA FURNISHED - CONTRACTOR INSTALLED VD = VA FURNISHED - FURNITURE DEALER INSTALLED VV = VA FURNISHED AND INSTALLED | MANUFACTURER | MODEL | MODEL NUMBER |
| E001 | N | CART, EMERGENCY, MOBILE, 66 X 52 X 22 | VC | MDMARK | RITTER | 222 |
| E002 | N | CART, GENERAL STORAGE, MOBILE, 48" X 32" X 22" | VC | WELCH ALLYN | 76720 | -- |
| E003 | N | CART, JANITORS | CC | -- | -- | -- |
| E004 | N | CLEANER, CARPET / FLOOR VACUUM, PORTABLE | VC | WELCH ALLYN | 7670-01 | -- |
| E005 | N | COMPUTER, MICROPROCESSOR, W/FLAT PANEL MONITOR WITH CAMERA, KEYBOARD | VC | WELCH ALLYN | 52401 | -- |
| E006 | N | COMPUTER, MICROPROCESSOR, W/FLAT PANEL MONITOR, KEYBOARD | VC | IVAC | TEMP PLUS II | -- |
| E007 | N | DISPENSER, PAPER TOWEL, SS, SURFACE MOUNTED, 1" C. FOLD, KIMBERLY CLARK | CC | -- | CPU | -- |
| E008 | N | DISPENSER, SANITARY NAPKIN, SS, SURFACE MOUNTED | VC | -- | MONITOR | -- |
| E009 | N | DISPENSER, SOAP, DISPOSABLE | VC | -- | -- | -- |
| E010 | R | DISPENSER, LOTION, DISPOSABLE | VC | ARJO | MAN SKY 600 | -- |
| E011 | N | DISPENSER, HAND SANITIZER, DISPOSABLE | VC | -- | -- | -- |
| E012 | N | DISPENSER, TOILET PAPER, SINGLE OVERSIZED ROLL | VC | STERICYCLE BIO SYSTEMS | WALL MOUNTED | -- |
| E013 | N | DISPOSAL, SANITARY NAPKIN, SS, SURFACE MOUNTED | VC | -- | 3 BOX HOLDER, CLEAR ACRYLIC | -- |
| E014 | N | DISPOSAL, SHARPS | VC | FACILITY STANDARD | -- | -- |
| E015 | N | NURSE CALL FULL STATION - EMERGENCY | CC | FACILITY STANDARD | -- | -- |
| E016 | N | ILLUMINATOR, FILM, SINGLE, WALL MOUNTED (PROCEDURE ROOM ONLY) | VC | -- | -- | -- |
| E017 | N | KIOSK, 54" TALL | VC | -- | -- | -- |
| E018 | N | MICROWAVE OVEN | VC | -- | -- | -- |
| E019 | N | MIRROR, FLAT GLASS, WITH SS FRAME | CC | -- | -- | -- |
| E020 | N | MIRROR, POSTURE, WALL MOUNTED, FULL HEIGHT | CC | -- | -- | -- |
| E021 | N | OTOSCOPE/OPHTHALMOSCOPE, WALL MOUNTED | VC | -- | -- | -- |
| E022 | N | OTOSCOPE HOLDER | VC | VEOVA | KIOSK V7 FA | -- |
| E023 | N | NURSE CALL PANEL | CC | -- | -- | -- |
| E024 | N | PRINTER, LABEL, AT WORK AREA | VC | -- | -- | -- |
| E025 | N | PRINTER, PRESTANDING | VC | -- | -- | -- |
| E026 | N | PRINTER, WRIST BAND, AT WORK AREA | VC | -- | -- | -- |
| E027 | N | PRINTER/FAX/CANNER/COPYER - DESKTOP | VC | -- | -- | -- |
| E028 | N | PWIS UNIT, COUNTER MOUNTED | VC | -- | -- | -- |
| E029 | N | REFRIGERATOR, FULL HEIGHT, 14 CUBIC FEET | VC | -- | -- | -- |
| E030 | N | REFRIGERATOR, MEDICAL GRADE, GLASS DOOR, STAINLESS STEEL UNDER COUNTER | VC | -- | -- | -- |
| E031 | N | SCANNER, INSURANCE CARD, AT WORK AREA | VC | -- | -- | -- |
| E032 | N | SHELF, UTILITY WITH MOPBOARD HOLDERS, STAINLESS STEEL, WALL MOUNTED | CC | -- | -- | -- |
| E033 | N | SHREDDER, PAPER, SECURITY | VC | -- | -- | -- |
| E034 | N | SHELVING, PLASTIC LAMINATE, MILLWORK TO ADA GUIDELINES | CC | -- | -- | -- |
| E035 | N | SIGNAGE, ROOM NUMBER | CC | -- | -- | -- |
| E036 | N | SIGNAGE, STATION IDENTIFICATION, HANGING FROM CEILING | CC | -- | -- | -- |
| E037 | N | SPECULA DISPENSER | CC | -- | -- | -- |
| E038 | N | SPHYGMOMANOMETER, ANEROID, WALL MOUNTED | VC | -- | -- | -- |
| E039 | N | TELEPHONE, DESK, MULTIPLE LINE | VC | -- | -- | -- |
| E040 | N | TELEPHONE, DESK, MULTIPLE LINE, WITH SPEAKERS | VC | -- | -- | -- |
| E041 | N | TELEPHONE, DESK, WITH SPEAKER | VC | -- | -- | -- |
| E042 | N | TELEPHONE, POLYCOM, VIDEO CONFERENCING, TANDBERG VIDEO EVENT | VC | -- | -- | -- |
| E043 | N | TELEPHONE, WALL MOUNTED, 1 LINE | VC | -- | -- | -- |
| E044 | N | TELEVISION, COLOR, 20" DIAGONAL | VC | -- | -- | -- |
| E045 | N | THERMOMETER | VC | -- | -- | -- |
| E046 | N | TRACK, CUBICLE, SURFACE MOUNTED | VC | -- | -- | -- |
| E047 | N | TV WALL MOUNTED | VC | -- | -- | -- |
| E048 | N | TV, WALL MOUNTED, FLAT PANEL, WITH DVD PLAYER | VC | -- | -- | -- |
| E049 | N | TV/DVD COMBINATION, 42" | CC | -- | -- | -- |
| E050 | N | WALL MOUNTED MONITOR 48" | VC | -- | -- | -- |
| E051 | N | WALL SHELVING, 6 TALL, 18" X 48" | VC | -- | -- | -- |
| E052 | N | WASTE DISPOSAL UNIT, BIO-HAZARDOUS | VC | -- | -- | -- |
| E053 | N | WASTE DISPOSAL UNIT, SHARPS W/ GLOVE DISPENSER | VC | -- | -- | -- |
| E054 | N | GRAB BAR, 42" HORIZONTAL, 36" CENTER LINE A.F.F. | CC | -- | -- | -- |
| E055 | N | GRAB BAR, 18" HORIZONTAL, 36" CENTER LINE A.F.F. | CC | -- | -- | -- |
| E056 | N | GRAB BAR, 16" VERTICAL, 41" A.F.F., HANDRAIL +35" A.F.F. | CC | -- | -- | -- |
| E057 | N | HANDRAIL AND CRASHRAIL, CRASHRAIL +6" A.F.F., HANDRAIL +35" A.F.F. | CC | -- | -- | -- |
| E058 | N | CORNER GUARD | CC | -- | -- | -- |
| E059 | N | SIGNAGE, "UNISER" | CC | -- | -- | -- |
| E060 | N | SIGNAGE, "STAFF ONLY", ON DOOR | CC | -- | -- | -- |
| E061 | N | PULL DOWN GRAB BAR | CC | -- | -- | -- |
| E062 | N | SIGNAGE, ROOM NUMBER AND NAME | CC | -- | -- | -- |

BIDDING DOCUMENTS
FULLY SPRINKLERED

BIDDING DOCUMENTS

03/27/2013

Revisions:

Date:

VA Northern Indiana Health Care System, Fort Wayne

2121 Lake Ave., Fort Wayne IN 46805

CONSULTANTS:

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Munster, IN 46321

(219) 836-2120 Fax (219) 836-1129

Approved: Medical Center Director

NAME: _____

SIGNATURE: _____

Approved: Medical Center Associate Director

NAME: _____

SIGNATURE: _____

Drawing Title

PARTIAL FIRST FLOOR FURNITURE AND EQUIPMENT PLAN

Approved: Engineering Service

NAME: _____ SIGNATURE: _____

Approved: Project Director

NAME: _____ SIGNATURE: _____

Project Title

Renovate First Floor East Wing for PACT

Location

2121 Lake Ave., Fort Wayne, IN 46805

Date

03/27/2013

Checked

DLW

Drawn

TKP

Project Number

610A4-12-107

Building Number

01

Drawing Number


AS-103

Dwg. 8 of 58


Office of Construction and Facilities Management

Department of Veterans Affairs


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

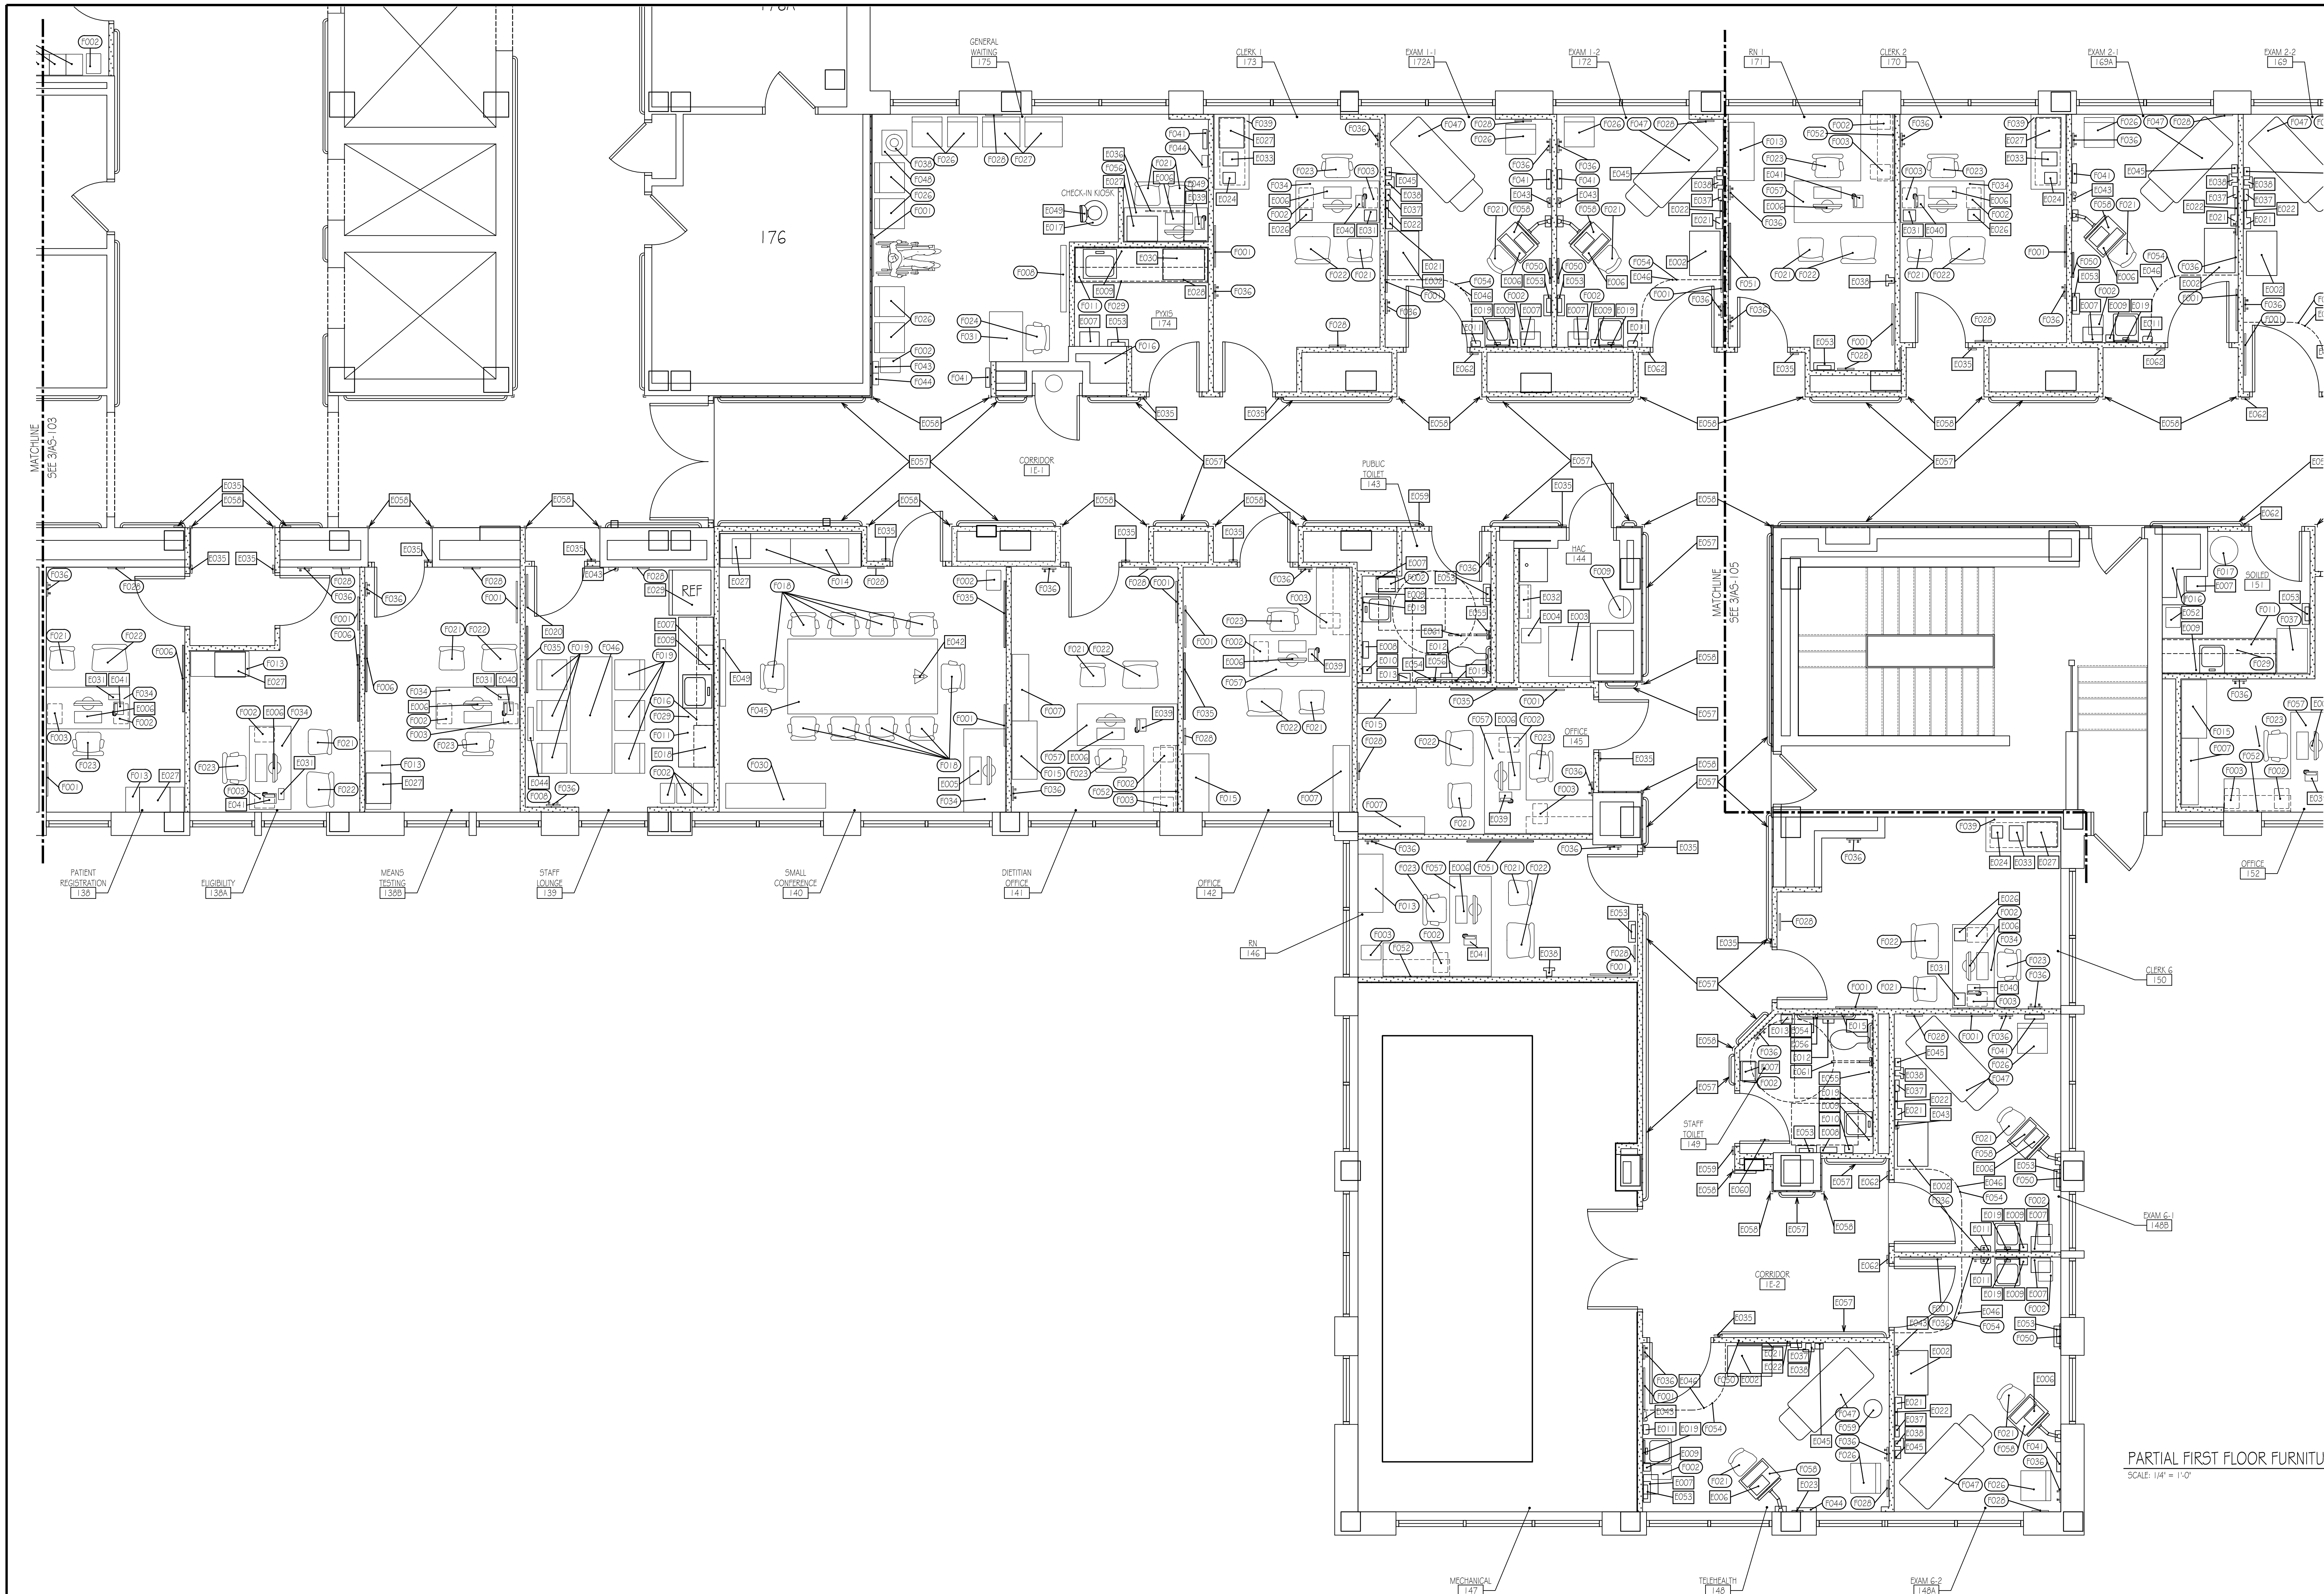

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one hundred inches = one foot

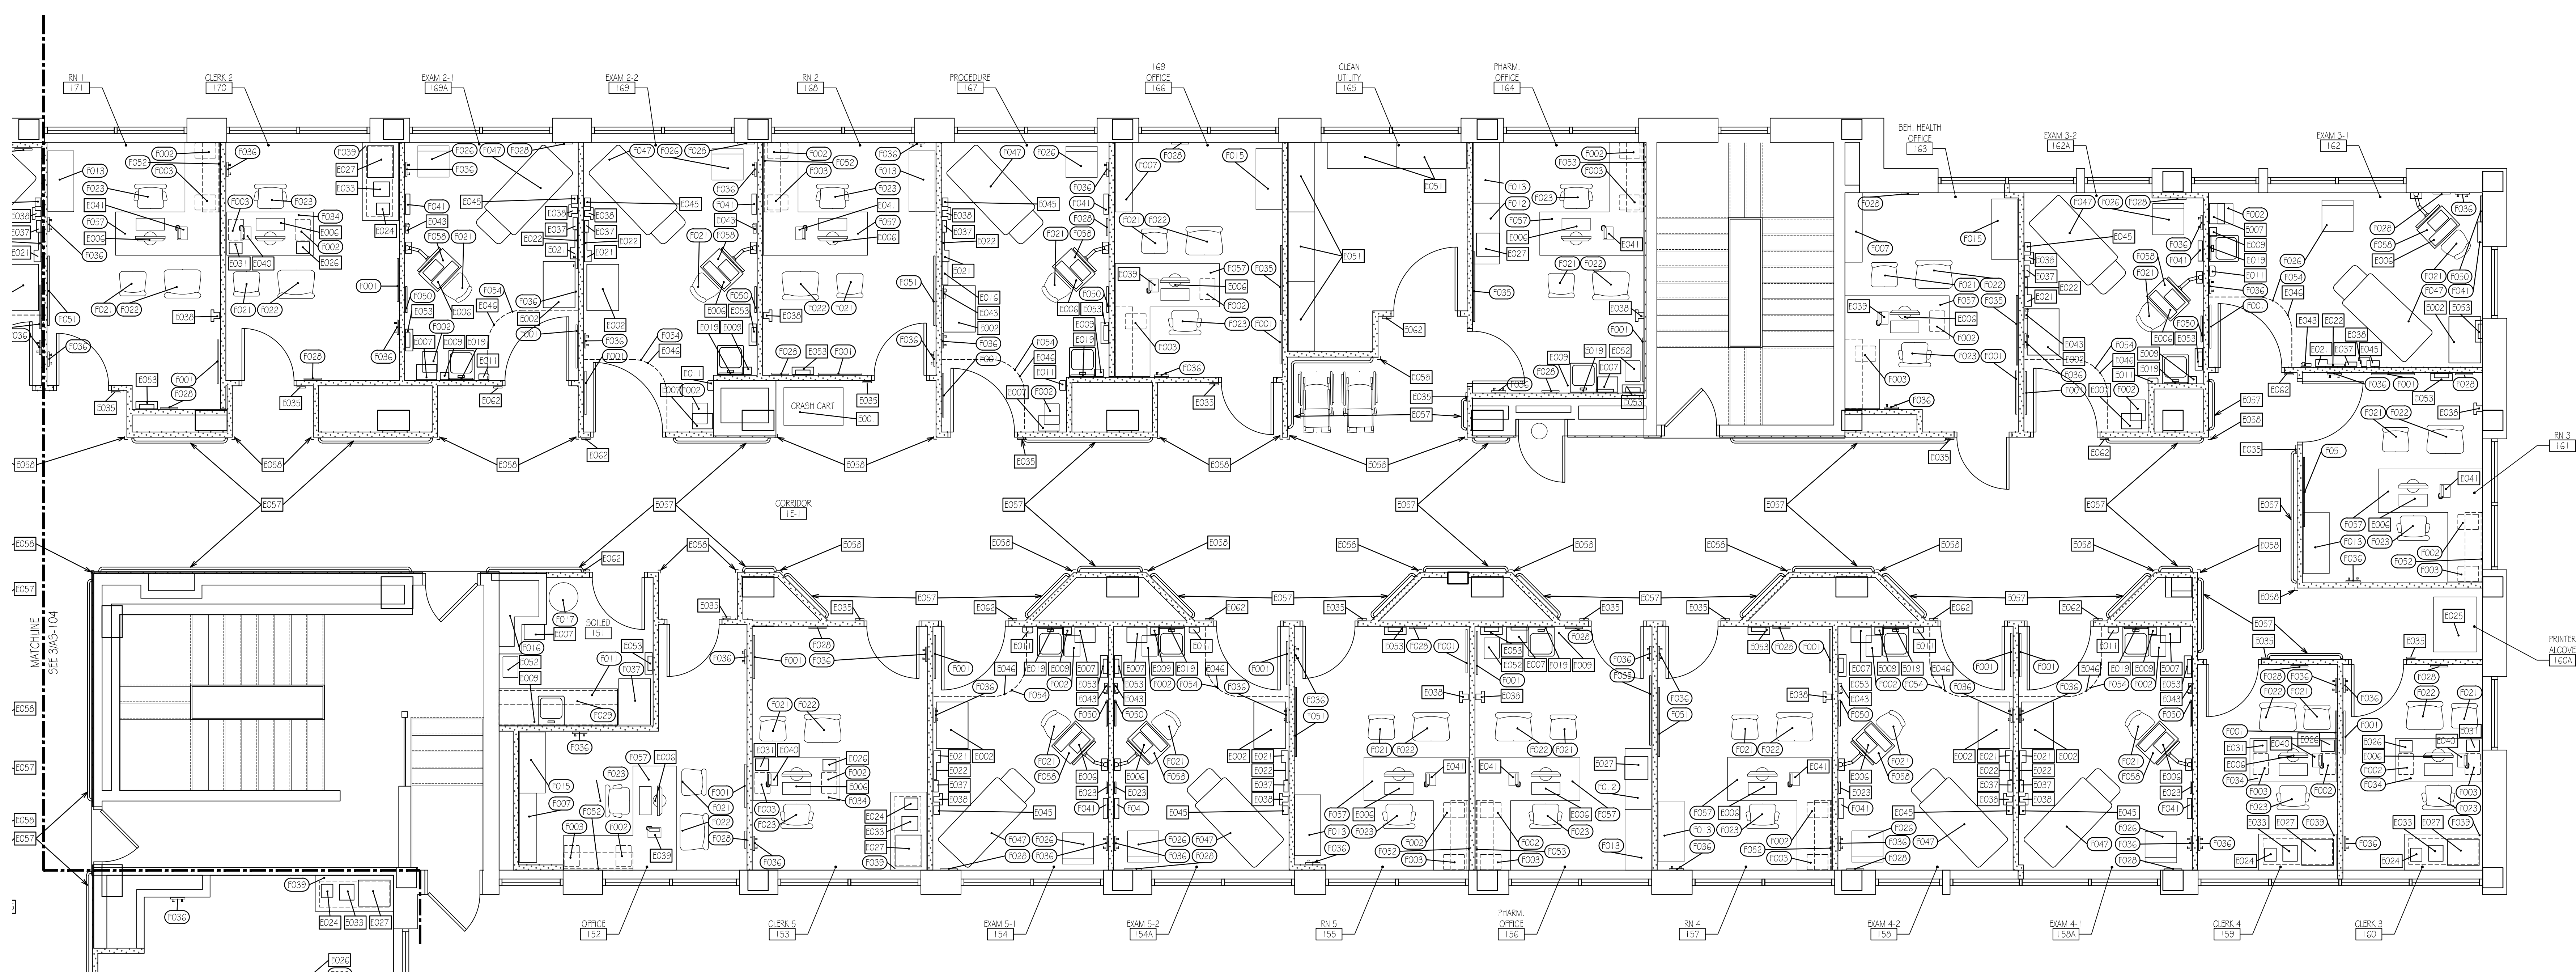

PARTIAL FIRST FLOOR FURNITURE AND EQUIPMENT PLAN
SCALE: 1/4" = 1'-0"

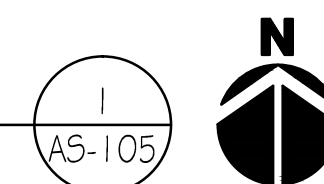

BIDDING DOCUMENTS FULLY SPRINKLERED

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|--|--|---|--|---|--|---|--|---|--|--|--|--|--|---|--|--|--|
| BIDDING DOCUMENTS 03/27/2013 Revisions: _____ Date: _____ | |  VA Northern Indiana Health Care System, Fort Wayne 2121 Lake Ave., Fort Wayne IN 46805 | | CONSULTANTS: USFin Development, LLC 1105 West Weir Street Litchfield, Illinois 62556 Viridian Architectural Design, Inc. 2020 East Washington Blvd., Suite 200 Fort Wayne, Indiana 46803 | | ARCHITECT/ENGINEERS:  AMERICAN STRUCTUREPOINT INC. 7280 SHADELAND STATION INDIANAPOLIS, IN 46256-9957 TEL 317.547.5580 FAX 317.543.0270 www.structurepoint.com  EnerTronics ENERGY TO EXCEL Engineering Corporation The Fairmont Building 92445 Calumet Ave., Suite 205, Munster, IN 46321 (219) 836-2120 Fax (219) 836-1129 | | Approved: Medical Center Director NAME: _____ SIGNATURE: _____ Approved: Medical Center Associate Director NAME: _____ SIGNATURE: _____ | | Drawing Title PARTIAL FIRST FLOOR FURNITURE AND EQUIPMENT PLAN Approved: Engineering Service NAME: _____ SIGNATURE: _____ Approved: Project Director NAME: _____ SIGNATURE: _____ | | Project Title Renovate First Floor East Wing for PACT Location 2121 Lake Ave., Fort Wayne, IN 46805 Date 03/27/2013 Checked DLW Drawn TKP | | Project Number 610A4-12-107 Building Number 01 Drawing Number AS-105 Dwg. 10 of 58 | | Office of Construction and Facilities Management  Department of Veterans Affairs | |
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